March 22, 2022

Heber City Corporation Attn: Jamie Baron 75 North Main Heber City, Utah 84032



Landmark Design LANDSCAPE ARCHITECTURE & PLANNING

Artspace Solar Gardens 850 South 400 West | Studio 104 Salt Lake City, Utah 84101 801.474.3300 www.ldi-ut.com

PLANNING COMMISSION STAFF REPORT

American Eagle Batch Plant - Commercial Final

Dear Jamie:

Landmark Design has reviewed the application for American Eagle Batch Plant - Commercial Final. The project plant is located at 2211 Airport road to the rear of the Heber Valley Animal Shelter and adjacent to an industrial storage yard to the west. The proposal consists of an existing building for Ace Disposal, that will be retained, and a new 40' tall concrete batch plant building for the American Eagle Ready Mix company proposed for the far south end of the site, which includes a covered conveyor system.

The project is located in the I-2 (Industrial) zone, with access to the 5.01-acre site provided by a road/easement through the adjacent property to the west. Development conditions, including road, water and other utility/infrastructure requirements, were addressed in the E.S.A.D Annexation Agreement as approved in 2017 and acknowledged in the concept application.

The new batch plant building occupies a 90' x 88' / 7,920 s.f. footprint), encompassing a shop, batch plant and office operations, with outdoor batching and storage of cement materials accommodated on the site. The proposal also retains the existing ACE Disposal building, scale and adjacent office building, and removes a storage building immediately north of these facilities.

The project includes four paved parking spaces, and approximately 12 unpaved parking spaces. While the code requires parking to be paved, the paved/unpaved configuration was approved at the concept level in deference to the use and setting. Several unpaved parking /vehicle storage spaces are also indicated.

The concept application was approved by the planning commission on June 22, 2021. The new batch plant building is different from the one approved at that stage, and is 40' tall, which exceeds the permitted 35' height limit in the I-2 zone. A building height up to 60' is may be approved as a conditional use. According to code requirements, the Planning Commission shall

consider at a minimum, but shall not be limited to the following mitigating options and building restrictions as requirements for such conditional use permits:

- A. Airport land zone height restrictions.
- B. Proximity to residential zones.
- C. Access to solar, air, and light for nearby properties.
- D. Building design (roof height step downs, eves).
- E. Roof design.
- F. Aesthetics.
- G. Compatibility with adjoining properties.

The application was reviewed by the DRM on February 16, 2022, at which time it was determined that the project meets the general requirements for Final Approval, with the submission of the following:

- Architectural plans (provided/meet requirements)
- Lighting plan with details on fixtures (provided/meet requirements)
- Bermed landscape treatment (provided drainage and topographic conditions preclude a full berm treatment)
- Avigation easement (not provided)
- Indicate location of dumpster and enclosure plans (not provided)

Staff recommends that American Eagle Batch Plant - Commercial Final be approved by the Planning Commission with the following findings and conditions:

Findings

- 1. The application is consistent with the Municipal Zoning Code.
- 2. The application is consistent with the General Plan.

Conditions:

- 1. Conditional Use approval for a 40' tall building (35' is maximum height permitted in I-2 Zone; 60' may be permitted as a conditional use)
- 2. Provide copies of an FAA Avigation Agreement
- 3. Revise drawings to include location of dumpster and enclosure plans for staff approval
- 4. All requirements of the City Engineer and Fire Officials shall be met see Engineering Letter)
- 5. All other Code Requirements shall be met.
- 6. Any other conditions or changes as articulated by the Planning Commission.

POTENTIAL MOTIONS

- 1. Approve
- 2. Continue
- 3. Deny

Staff Recommended Option – Approval with Conditions

Please feel free to call our office with any questions or concerns regarding this project.

Sincerely

Mark Vlasic, PLA, ASLA, AICP

Principal and President Landmark Design 850 South 400 West #104 Salt Lake City, Utah 84101

cc: file

Tony Kohler, Heber Planning Department

POTENTIAL MOTIONS

Staff Recommended Option – Approval	
I move to approve American Eagle Batch Plant - Co Conditions in the conclusions of the Staff Report. as	_
Alternative 2 – Continuance	
I move to continue American Eagle Batch Plant - Co [DATE], with direction to the applicant and/or Staff render a decision, as follows:	_
Alternative 3 – Denial	
I move to deny American Eagle Batch Plant - Comn	nercial Final with the following findings:
ACCOUNTABILITY	
Department: Staff Member:	Planning Department Mark Vlasic (Jamie Baron)

EXHIBITS

- 1. Planning Review Checklist
- 2. Drawings and Attachments

Exhibit 1

Planning Review Checklist

Planning Review Checklist

Project Name: American Eagle Ready Mix Concrete Batch Plant – Commercial

Final

Project Type: and Conditional Use

DRM Date: February 16, 2022

Project Address: 2211 South Airport Road

Property Owner / Name: American Eagle Ready Mix Utah LLC / Doug Clements

Company Name / Agent: Berg Engineering / Paul Berg

Project Details

Project Description: Construction a concrete batch plant for the American Eagle Ready

Mix company. Plant will service about 30 trucks a day.

Acres: 5.01 Number of Lots 1

Current Zone: I-1 (I-1 Industrial Zone)
Date Submitted: January 20, 2022
Date Reviewed: 02/16/2022
Planning Commission Date: 03/22/2022

Location: 2211 South Airport Road

Parcel(s): 1 parcel – 4.94 acres – Wasatch County (21-3062)



Zone: I-2 Industrial Zone / AP Overlay Zone 2 (NW Corner) and 10

Sex Oriented Business Overlay North +/- 1 acre



General Plan Designation: Land Use – Industrial

Current Use: DCD Transfer and Recycle Center / Dunn Recycling / Diamond K

Waste Inc.

Adjacent Uses: North – Heber Valley Animal Shelter – City

East – Industrial Yard - City

West – Industrial Yard with residence – County?

South – Agriculture – County?

Land Use Authority: Planning Commission

Action Type: Administrative

Planner: Mark Vlasic, Landmark Design (Jamie Baron, Planner)

General Review

- Only Civil and Landscape drawings are in Civic Review. Building concept was provided in an earlier review, but this design has been modified, keeping the existing building is being modified rather than the
- No Lighting or Photo metric information provided outdoor lighting shall be shielded to direct light and glare only onto the premises.
- No architectural plan or elevation drawings to verify materials, height, natural colors.
 - Height And Size Requirements: All buildings in the I-2 Industrial Zone shall be limited in heightto thirty-five (35) feet (18.45.050). Height of building may need Conditional Use.
- Landscape Total site 4.94 Acres (215,186 SF)
 - o Landscape area per plan 54,715 SF
 - Cobble and gravel non-landscape per plan 139,205 SF
 - 20' set back from public street right-of-way appears adequate, no dimensions
 - o 10' wide landscape berm along right-of-way frontages it is a drainage swale not a berm.
 - I-2 1 tree / 50' of frontage East PL is +/-740' = 15 trees required along east.
 - 11 new trees and 10 existing trees per plan
 - 20% of landscape areas shall be planter beds, containing of rock or bark mulch, trees, shrubs, and ornamental grasses. NO shrubs or grasses have been specified.
 - 40% of all landscape area shall be covered with planted vegetation. Many large expanses of stone mulch NOT meeting the requirement.
- No irrigation plan
- All storage and warehouse developments shall be fenced in a manner which will provide adequate security and a deterrent from public access – OK
- Condition: need to apply for an avigation agreement?

ZONE I-2

PROPOSED USES: Concrete Batch Plants are not specifically permitted use nor are they not permitted. See Permitted Primary Uses F.

Building is a modification of an existing building and has an elevated tower to 40' with additional bulk storage silos and a covered conveyor system. Bulk materials of sand and gravel are in the yard area with truck parking. The site will be fenced.

Setback Requirements: In the I-2 zone, all buildings shall be set back at least twenty (20) feet from any public street right-of-way line.

Height And Size Requirements: All buildings in the I-2 Industrial Zone shall be limited in heightto thirty-five (35) feet (18.45.050). **Height of building may need Conditional Use.**

- Will need final lighting/photometric plans/details, in addition to elevations calling out materials and percentages, colors/color boards. at final submittal stage.
- Condition: need to apply for an avigation agreement?

Special Provisions:

- 1. Trees shall be planted along all street frontages. Trees should be planted at least one forevery fifty (50) feet of street frontage. No Street Frontage at this time.
- All storage doors, entrances into storage and warehousing, and parking in storage and warehouse developments shall be accessed from internal private streets and driveways.MET in concept
- 3. All storage and warehouse developments shall be fenced in a manner which will provide adequate security and a deterrent from public access. Met In concept
- 4. Building and structures shall use natural colors. Existing Building with modifications. PROVIDE MATERIAL AND COLOR BOARDFOR FINAL
- 5. All outdoor lighting shall be shielded to direct light and glare only onto the premises.PROVIDE LIGHTING PLAN AND PHOTOMETRICS ANALYSIS FOR FINAL
- 6. All required off-street parking shall be hard-surfaced; loading zones, outdoor storage areas, and a portion of the employee parking may be compacted gravel, provided those areas are:
 - (1) not located adjacent to the primary public entrance to the building; and (2) located or screened in such a manner to minimize visibility of the area as viewed from the public streetand adjoining properties. There are some parking in non-paved areas at the rear

Other Departments: Engineering letter required.Other Requirements:

Code Review

17.14 Requirement of Adequate Public Facilities: Will connect to City Infrastructure. Will bereviewed by Engineering.

17.20 Plans

17.20.010 Concept Plans

The Concept Plan shall be drawn to a scale no smaller than one inch equals one hundred (100)feet and shall include:

- 1. Conceptual layout of the following:
- 1. Proposed streets, in relation to the existing and planned streets within one-fourth mile of the subdivision: OK
- 2. Lots, including lot sizes: County indicates 4.94 acre lot size
- 3. Building pads for residential projects N/A
 - 4. Buildings for multi-family or nonresidential projects, including building area 3-Drenderings provided, 2-story (35') structures. Not Rendered
 - 5. Parking for nonresidential and multi-family residential projects OK
 - 6. Open space, as required by the zone no table/calculations provided. No trailon-site.
 - 7. Landscaping, as required by the zone -
 - 2. Data Table containing the following:
 - 1. Uses –
 - 2. Open space calculations, as required by the zone
 - 3. Landscaping calculations, as required by the zone-
 - 4. Parking analysis NOT PROVIDED Last time 2 employees, 1 stall per 2 employees required. 13 stalls provided.

17.20.030 Final Construction - Plans and Final Plat

2. The Final Plans shall be drawn to a scale no smaller than one-inch equals one hundred (100) feet for overall sheets and one-inch equals forty (40) feet for plan and profile sheets.

In addition to all of the requirements of the preliminary plans, the following shall also be included with the final plans:

- 1. Data Table containing the following:
 - a. Uses
 - b. Density
 - c. Open space calculations, as required by the zone
 - d. Parking analysis, as applicable
- 2. Landscaping plan, including a data table relating to the applicable landscaping requirements of Chapter 18.76.
- 3. Lighting plan as outlined in Section 18.78.050, including a data table relating to the applicable lighting requirements of Chapter 18.78.
- 4. Exterior materials Board for all non-residential and multi-family buildings.
- 5. Scaled color elevations of all non-residential and multi-family buildings, including a data table relating to the applicable design standards.
- 6. Record of survey map;
- 7. Checklist of all items discussed at preliminary approval.

17.38.040 Landscape Requirements

Each application for commercial development approval shall satisfy the requirements found in Chapter 18.76 of the Zoning Ordinance, also known as Title 18 of the Heber City Code, and the following requirements.

- 1. All setback areas adjacent to a public street shall be fully landscaped and properly maintained. Trees shall be planted at no less than twenty (20) feet on center, on average, and shall have no less than a two (2) inch caliper, except that no trees shall be planted within forty-five (45) feet of an intersection clear view area. Trees may be planted in clusters to create a more natural and/or screening effect, if appropriate.
- 2. All ground areas shall contain grass, or another ground cover acceptable to the Planning Commission, and shall be irrigated sufficiently. Shrubs, flower beds, decorative rocks, and other appropriate landscaping is highly encouraged.
- 3. All landscaped areas shall be maintained using a sprinkling and/or irrigation system which is capable of being engaged automatically on a regular basis. Each applicant for commercial development shall submit a complete and detailed landscaping plan for review by the Planning Commission concurrently with submission of other documents for review by the Planning Commission.
- 4. All landscaped areas shall be maintained on a regular basis and be kept neat and clean. If the Zoning Administrator determines the maintenance requirement has not been satisfied, the Zoning Administrator shall notify the property owner. The Zoning Administrator will detail the lack of maintenance and inform the owner that a continued lack of maintenance will warrant issuance of a Class C misdemeanor charge against the

property owner under the authority of the Utah Code §10-9-1003 and Chapter 17.68 herein.

18.45 I-2 Industrial Zone

18.45.010 Objectives - Characteristics

- A. The I-2 industrial zone has been established for the primary purpose of providing a location for the creation of jobs where manufacturing, processing, warehousing and fabrication of goods and material can be carried on most appropriately and with minimum conflict or deleterious effects upon surrounding properties. Other objectives in establishing the zone are to promote the economic well-being of the people and to broaden the tax base.
- B. This zone is characterized by a mixture of industrial, manufacturing and processing establishments with intermittent open land that is served by streets, power, water andother utilities and facilities or where such facilities can be readily provided.
- C. In order to accomplish the objectives and purposes of this title and to stabilize and protect the essential characteristics of this zone, the regulations set out in this chaptershall apply in the I-2 industrial zone.

18.45.020 Permitted Primary Uses

The following buildings, structures and uses of land shall be permitted in the I-2 Industrial Zone upon compliance with requirements as set forth in this Section:

- A. Accessory buildings and parking lots incidental and accessory to other permitted uses;
- B. Agriculture, farm machinery storage sheds, vegetable and fruit packing and processingplants, and livestock raising;
- C. Airport and associated activities;
- D. Earthmoving and equipment storage, gas and oil storage facilities, public buildings and public utility buildings, craft shops, and accessory signs;
- E. Fences, walls and hedges;
- F. Manufacturing, compounding, processing, packaging, fabrication, storage and warehousing of goods and materials, except the processing of animal byproducts and livestock feed yards, and except steel manufacturing plants, oil refineries, wallboard manufacturing and similar establishments which emit offensive fumes, smoke, noise, dust, odor, etc.;
- G. Retail commercial uses and cafes; however, no retail commercial transaction norbusiness may be conducted within a storage shed.
- H. Water wells, utility transmission lines, dams, pumping plants, power plants, sewagetreatment plants subject to review and approval of the State Division of Health;
- I. Research Services (including laboratories, scientific, medical, chemical, applied

- physics, mechanical, electronic, biological, genetic or other similar experimental research, product development or testing facilities);
- J. Office, business, professional or research;
- K. Printing, publishing and allied industries;
- L. Marketing, Telemarketing, and Advertising Services;
- M. Communications including radio and television broadcasting, telephone companyoffices, recording and sound studios, motion picture studio;
- N. Data Processing Services;
- O. Recycling facilities when enclosed by a security fence and screened with sight obscuringfencing and/or evergreen landscaping along public street right of ways;
- P. Automotive & Equipment Repair;
- Q. Hotels, subject to Planning Commission approval of height, proximity, and userestrictions;
- R. Other uses similar to the foregoing uses which are ruled by the Planning Commission tobe in harmony with the intent of this zone.

18.45.030 Area Requirements

- A. There is no minimum lot area requirement and no maximum building size in the I-2Industrial Zone.
- B. Each project approved under this section must be fully located within the I-2 IndustrialZone.
- C. Limitations of Buildings Used for Retail Business.
 - 1. Findings. The Heber City Council makes the following findings:
 - a. One main intention of the Heber City Council in limiting the gross floor area of buildings used for retail business is to incorporate those goals anddirectives of the Heber City General Plan, including but not limited to those specific directives and provisions which identify the importance of and intentions surrounding the City center addressed in said GeneralPlan.
 - b. The Heber City Council adopted the Heber City General Plan to guide anddirect future development and land use decisions in Heber City.
 - c. The Heber City General Plan evidences the community's goals and objectives for the future of Heber City, and identifies the old town as the heart of the community, and makes the development and preservation of the City center critical to the General Plan's vision for Heber City's future.
 - d. The Heber City General Plan contemplates building on Heber's strengthsfrom the inside out, by focusing on the City center including the existing central business district.
 - 2. Gross floor limitation, I-2 Zone.

Retail establishments shall not exceed 60,000 square feet of gross floor area within the I-2 Zone. No retail establishment shall be permitted to place any onebuilding or any combination of buildings that exceed 60,000 square feet within said Zone. In no event shall any retail establishment, corporation, business, or entity have one or more buildings within less than 1,000 feet of each other, wherein the building or buildings would exceed a total of 60,000 square

feet. Attempts to circumvent or exceed this maximum, 60,000 square feet, shallbe strictly prohibited.

- 3. Definitions. The following definitions shall apply to this Section, 18.45.030:
 - a. "Retail Establishments" means retail business or businesses, conducted intwo or more buildings, where the retail business or businesses:
 - are engaged in the selling of similar or related goods, wares ormerchandise, and operate under common ownership or management, or
 - (2) share check stands, storage facilities, a warehouse, or adistribution facility, or
 - (3) otherwise operate as associated, integrated or co-operative business enterprises under common ownership or management.
 - "Combination of Buildings" means two or more buildings that are within1,000 feet of each other as measured from the outside exterior walls of two of the buildings.
 - "Common Ownership or Management" means owned, leased, possessed,managed or otherwise controlled, in any manner, directly or indirectly,
 - (1) by the same individual(s) or entity(ies), including but not limited to corporation(s), partnership(s), limited liability company(ies) ortrust(s), or
 - (2) by different individuals or entities, including but not limited to corporations, partnerships, limited liability companies or trustswhere such individual(s) or entity(ies) have a controlling ownership or contractual right with the other individual(s) or entity(ies) with respect to the retail businesses, or where the same individual(s) or entity(ies) act in any manner as an employee, owner, partner, agent, stockholder, director, member,officer or trustee of the entity(ies).
 - d. "Gross Floor Area" shall mean the sum of:
 - (1) the total horizontal area, in square feet, of all floors of a building, as measured at outside the exterior walls and

- including all interiorcourtyards, and
- (2) the total horizontal area, in square feet, of all portions of the siteoutside of the exterior walls of buildings used for the display, storage, or sale of any goods, wares or merchandise. For the purpose of this section an interior courtyard means a space bounded on three or more sides by walls but not a roof.
- e. "Retail Business" means a business engaged in the sale of goods to individual consumers, usually in small quantities, and not to be placed in inventory for resale. A retail business does not include: (a) health centers, governmental uses, community centers, theaters, or religious or fraternal uses, or (b) a business where retail sales are an incidental or accessory use to the primary use. This definition shall not include churches, public schools, hospitals, public civic centers or public recreational facilities, or other facilities owned by, or operated strictly forthe benefit of, the public.

18.45.040 Setback Requirements

In the I-2 zone, all buildings shall be set back at least twenty (20) feet from any public street right-of-way line. A ten (10) foot wide landscaped berm is required along all public street right-of-way frontages. In the event of competing set back requirements as a result of building coderestrictions, the most restrictive shall govern.

18.45.050 Height And Size Requirements

All buildings in the I-2 Industrial Zone shall be limited in height to thirty-five (35) feet. No buildings taller than thirty-five (35) feet shall be permitted in the I-2 Industrial Zone except as approved by the Planning Commission pursuant to approval as a conditional use and approvedby the city Council.

Upon application for a conditional use to exceed the thirty-five (35) foot height limitation for developments, the Planning Commission shall consider at a minimum, but shall not be limited to the following mitigating options and building restrictions as requirements for such conditional use permits. No building that receives a conditional use permit shall be approved over 60 feet in height.

- H. Airport land zone height restrictions.
- I. Proximity to residential zones.
- J. Access to solar, air, and light for nearby properties.
- K. Building design (roof height step downs, eves).
- L. Roof design.
- M. Aesthetics.

N. Compatibility with adjoining properties.

18.45.060 Special Provisions

- A. Trees shall be planted along all street frontages. Trees should be planted at least one for every fifty (50) feet of street frontage.
- B. All storage doors, entrances into storage and warehousing, and parking in storage and warehouse developments shall be accessed from internal private streets and driveways.
- C. All storage and warehouse developments shall be fenced in a manner which will provide adequate security and a deterrent from public access.
- D. Building and structures shall use natural colors.
- E. All outdoor lighting shall be shielded to direct light and glare only onto the premises.
- F. All required off-street parking shall be hard-surfaced; loading zones, outdoor storage areas, and a portion of the employee parking may be compacted gravel, provided thoseareas are: (1) not located adjacent to the primary public entrance to the building; and
- (2) located or screened in such a manner to minimize visibility of the area as viewed from the public street and adjoining properties.
- G. Properties shall be kept in a clean and orderly manner.

18.45.065 Compatibility With Residential Zones

When any industrial building or use adjoins any residential zone, a setback area containing a landscaped berm of at least four (4) foot tall and/or an eight (8) foot tall sight obscuring fenceshall be erected as a buffer between all industrial and residential zones, as determined by the Planning Commission. In the event the Planning Commission elects to require a landscaped berm, such berm shall contain evergreen trees at least four (4) foot tall and deciduous trees having a caliper of at least three (3) inches. In determining whether to require a fence, berm, or both, the Planning Commission shall consider at a minimum, but shall not be limited to the following factors:

- A. Compatibility with adjoining properties.
- B. The future use of the land as identified on the City's general plan.
- C. Intensity of industrial use.
- D. Proximity of residential units.
- E. Additional landscaping and screening.
- F. Fences and setbacks being used.

18.45.070 Supplementary Requirements

See also supplementary requirements and procedures applicable within the I-2 Industrial Zone.

18.78.040 Lighting Standards

- 1. Non-Residential and Multi-Family Residential Standards
 - 1. All lighting shall be full cut-off and directed downward. The lamp/bulb shall not be visible from the property line.
 - 2. Height All fixtures shall be mounted no higher than 20 feet, or 16 feet where adjacent to or within residential zones.
 - 3. Light Containment In no case shall Direct Light be allowed beyond the property line and in no case shall the bulb be visible from beyond the property line. Site lighting shall be considered as to reduce the amount of Reflective Light leaving the site.
 - 4. LED Required All fixtures shall use an LED bulb.
 - 5. Shoebox fixtures are prohibited. All poles and fixtures shall be of a decorative design.
 - 6. All lighting shall use a bulb of 3000 K or less in color.
 - 7. In no case shall the total lumens for a single site exceed 100,000 lumens per net acre.
 - 8. All non-residential exterior lighting shall be shut off during non-business hours.
 - 1. Some lights may be dimmed when connected to an automated dimmer as determined on a case by case basis by the Planning Commission when:
 - 1. The lighting is essential to the security of the site.
 - 2. The site offers services outside of employed business hours.
 - 2. Dimmed lights must be dimmed by a minimum of 50%. This may be accomplished by dimming all lights by 50% or by a combination of dimmed and shut off lights. In no case can any lights be running at 100% output.
 - 3. Motion sensor security lights may operate during non-business hours.
 - 9. Businesses that operate 24 hours a day and are adjacent to residential property shall dim exterior lighting so as to reduce the impact to surrounding residential properties while maintaining site security for the patrons of the said business.

17.38 Commercial Developments

- 17.38.030 Improvements: Engineering has reviewed the plans.
- 17.38.040 Landscaping
 - For commercial development approval shall satisfy the requirements found in Chapter 18.76 of the Zoning Ordinance, also known as Title 18 of the Heber City Code, and the following requirements.
 - All setback areas adjacent to a public street shall be fully landscaped and properly maintained. Trees shall be planted at no less than twenty (20) feet on center, on average, and shall have no less than a two (2) inch caliper, except thatno trees shall be planted within forty-five (45) feet of an intersection clear view area. Trees may be planted in clusters to create a more natural and/or screeningeffect, if appropriate.. The Design Criteria Require 50 feet average. There is 130 feet of frontage and 3 trees.
 - All ground areas shall contain grass, or another ground cover acceptable to

- the Planning Commission, and shall be irrigated sufficiently. Shrubs, flower beds, decorative rocks, and other appropriate landscaping is highly encouraged. The Landscaping plan indicates that all ground areas are covered by landscaping, containing shrubs, flower beds, and decorative rocks.
- All landscaped areas shall be maintained using a sprinkling and/or irrigation system which is capable of being engaged automatically on a regular basis. Eachapplicant for commercial development shall submit a complete and detailed landscaping plan for review by the Planning Commission concurrently with submission of other documents for review by the Planning Commission.. The landscaping plan indicates that there will be an irrigation system.

• 17.38.050 – Design Requirements:

- In addition to the requirements of the Heber City Subdivision and Zoning Ordinances, the following design requirements shall apply to each commercialdevelopment approved under this Chapter.
- TRASH STORAGE. No trash, used materials, or wrecked or abandoned vehicles orequipment shall be stored in an open area.. There is a trash enclosure identified on the plans.
- TRASH COLLECTION AREAS. All trash collection areas shall be designed to be compatible with the proposed project.. The dumpster block shallmatch the building.
- LIMITED ACCESS. Generally speaking, commercial zones in Heber City are locatedin areas with a higher potential for traffic congestion. Therefore, access to commercial developments shall be limited to the extent possible in order to maintain traffic flow. Access should be addressed in an appropriate manner in accordance with section 17.38.030 herein.. The site does not require any additional accesses.
- COMPATIBILITY. The Planning Commission may make recommendations to the applicant in order to improve compatibility with surrounding development. This requirement is intended to ensure future compatibility with the subject proposalas well, and should be viewed in that manner by each applicant. If changes to theanticipated structure are made, these changes should be submitted to the Zoning Administrator at the earliest possible date. The Zoning Administrator will determine whether the changes need to be reviewed by the PlanningCommission.
- ADOPTION OF DESIGN CRITERIA. The November, 2006, Heber City Commercial Districts: C-2 and C-4 Zones Design Standards and Guidelines, attached as ExhibitA, is adopted herein by reference. Copies of the Heber City C-2 and C-4 Design Standards and Guidelines shall be on file in the City Recorder's Office for the useand examination of the public.
- APPLICABILITY. Where, in any specific case, differences between the Heber

City C-2 and C-4 Zone Design Standards and Guidelines and the adopted Building Codes specify different materials, methods of construction or other requirements, the specific requirements of the Building Code shall be applicable.

• 17.38.080 – Supplementary Requirements:

- LAYOUT OF BUILDINGS. Unlike other developments approved under this Title, commercial developments may have more than one main structure per parcel. Insuch cases the applicant shall provide a project master plan to the Planning Commission indicating the location and size of each proposed structure. Additionally, the project master plan shall indicate accessory buildings, if any. Each structure in the commercial development is required to satisfy the building permit requirements of Title 18.12.. There is only one building on this parcel.
- SETBACKS. Setback requirements in commercial zones may be flexible, but must be approved by the Planning Commission. The Planning Commission shall consider impacts on adjacent parcels, traffic, pedestrian access, landscaping andother relevant issues when recommending setback requirements. Thebuilding is setback 26 feet. The design criteria require a 20' minimum and a 40' maximum.
- SURFACE WATER DRAINAGE. Surface water from roof tops, parking lots or irrigation ditches shall not be allowed to drain onto adjacent lots or streetsexcept after written agreement between the parties involved.
 Drainage is reviewed by engineering.
- FUTURE DEVELOPMENT. Whenever a front or side yard is required for a buildingwhich abuts on a proposed street which has not been constructed but which hasbeen designated by the Planning Commission as a future street, the depth of such front or side yard shall be measured from the planned street lines.
- SOLID WASTE AND SEWAGE. Each commercial development shall be reviewed bythe Solid Waste Department for recommenced solid waste disposal. Where domestic sewage disposal facilities are used which are not connected to a public sewer, approval of such facilities shall be obtained from the Health Department before a building permit is issued. Solid Waste and Sewage is reviewed by engineering.
- MOTOR VEHICLE ACCESS. Access to all buildings in a commercial project shall becontrolled as follows:
 - § Each driveway shall be not more than thirty (30) feet in width in any commercial or industrial zone measured at right angles to centerline of

the driveway. On corner lots, no driveway shall be closer than fifty (50)feet to the point of intersection of the front property line which

- abuts upon a street.. There are no drive ways proposed with this project.
- § Each commercial development shall install curb and gutter to facilitatesurface drainage. The paved areas have a curb and gutter.
- Each commercial development shall present a plan for public utilities and services. These plans may be reviewed by utility providers for recommendations.

17.40 Improvements

• **17.40.010 – Requirements:** All required improvements have been reviewed by Engineering.

18.72 Off Street Parking and Loading

- 18.72.030 Parking Space Requirements Designated:
 - J. Industrial, manufacturing and wholesale establishments shall have one parking space per two employees based on the largest shift;
- **18.72.040 Parking Space Requirements Location and Control:** All off-street parkingshall be on the same lot as the use.
- **18.72.070 Access to Parking Facilities:** All parking areas are accessible.
- **18.72.080 Circulation within Parking Areas:** Parking area with more than one aisle must be so arranged that a car need not enter the street to reach another aisle withinthe same parking area. **N/A.** Traffic does not have to enter the street to get to other drive isles.
- **18.72.100 Lighting:** There are no residential areas adjacent to the site.
- **18.72.130 Landscaping Requirements:** All off-street parking lots designed for five or more vehicles shall be bordered by a curb and/or a landscaped strip at least eight feet inwidth. **Complies.** The parking area is surrounded by a landscaping area of more than 8'.

18.76 Landscaping

18.76.030 Landscape Standards

- General
 - Zeroscaping is prohibited in all zones.
 - Xeriscaping is permitted in all zones.
 - Natural vegetation are permitted for open space areas when specified by zone.
 - Vegetation coverage is measured by the area of the plant at full seasonal coverage. Trees may account for up to 80 square feet per tree.
- Non-Residential and Multi-Family Residential Standards.

- A minimum of 20% of landscaped areas shall be planter beds, containing a combination of rock or bark mulch, trees, shrubs, and ornamental grasses.
- A minimum of 40% of all landscaped areas shall be covered with planted vegetation.
- Community Gardens may be counted toward a landscaping and/or open space requirement for Multi-Family Residential developments.
- Automated irrigation systems are required.
- Landscaping shall be completed prior to the issuance of a Certificate of Occupancy. For phased developments, the landscaping within each phase shall be completed with the phase.
 - A landscaping bond may be used during non-growing seasons, as determined by the Planning Director or designee. Bonds shall cover 110% of the costs of the bond estimate included in the bond agreement.
- Single Family Residential Standards.
 - In any residential or residential-agricultural zone, all portions of the required front and side yards adjacent a street that are not covered by permitted structures, driveways or pedestrian paths shall be landscaped.
 - Required landscaping shall be installed within 24 months of the date of receiving an occupancy permit for the property.
 - A minimum of 10% of the front and street side yards shall be covered with planted vegetation.

18.60 Plot Plan Required: A landscaping plan is required

18.78 Lighting

18.78.040 Lighting Standards

- o Non-Residential and Multi-Family Residential Standards
 - § All lighting shall be full cut-off and directed downward. The lamp/bulb shall not be visible from the property line. The building lightsand pole lights are full cut-off. The emergency lights are not; however, they will not be used unless of an emergency (i.e. fire or burglary).
 - § Height All fixtures shall be mounted no higher than 20 feet, or 16 feetwhere adjacent to or within residential zones. The pole lights are identified as 23' tall from the pavement. This site is not adjacent to a residential area.
 - § Light Containment In no case shall Direct Light be allowed beyond the property line and in no case shall the bulb be visible from beyond the property line. Site lighting shall be considered as to

reduce the amount ofReflective Light leaving the site. The photometric plan does not extend to the property line. The site is part of a commercial subdivision and is bordered by businesses and Main Street.

- § LED Required All fixtures shall use an LED blub. All lighting proposed contain an LED Bulb.
- § Shoebox fixtures are prohibited. All poles and fixtures shall be of a decorative design. The proposed lighting plan does not contain any shoebox fixtures, but the pole lights are not decorative.
- § All lighting shall use a bulb of 3000 K or less in color. The emergency lights are 6000K in color and more information is needed onthe pole lights.
- § In no case shall the total lumens for a single site exceed 100,000 lumensper net acre. ? The building lights put out 1,788.76 lumens and there are 15 fixtures, equaling 26,831.4 lumens. The lumen output for the pole lights is not known. The site is 0.54 acres in size.
- § All non-residential exterior lighting shall be shut off during non-businesshours. The lighting plan includes an auto shut off at dusk.
- § Some lights may be dimmed when connected to an automated dimmer as determined on a case by case basis by the Planning Commission when:
 - The lighting is essential to the security of the site.
 - The site offers services outside of employed business hours.
 - Dimmed lights must be dimmed by a minimum of 50%. This
 may be accomplished by dimming all lights by 50% or by a
 combination of dimmed and shut off lights. In no case can any
 lights be running at 100% output.
 - Motion sensor security lights may operate during nonbusinesshours.
- § Businesses that operate 24 hours a day and are adjacent to residential property shall dim exterior lighting so as to reduce the impact to surrounding residential properties while maintaining site security for thepatrons of the said business.

18.78.050 Lighting Plan Required – A lighting plan is required.

Exhibit 2

Drawings and Attachments

HEBER CITY WATER RIGHT ACTION REPORT

	Date:				
Project Name:					
Project Address	S:				
Name of Develo	per:				
PRIOR LAND USE					
• Irrigated Land:		Ac			
• Non-Irrigated Land:		Ac			
-	Total:	Ac			
PROPOSED PROJECT USE					
• Residential Units:		Units			
• Residential Avg Irr Land per Lot:		Ac <<	(For Mixed Use developments, leave as zero an	d show all Outdoor in	'Other" below.)
• Non-Residential ERU's:		ERU's			
• Other/Common Area Irr Land:		Ac			
• Non-Irrigated Land:		Ac			
WATER RIGHT REQUIREMENT			Timpanogos Irr Additional D	ata	
• Residential, Indoor/Culinary: (ERU's x 0.4	3 AF/ERU)	AF	- Total Reqd if D (AF / 3.0 AF/Sh):	Shares A	
Residential, Outdoor/Irr: (ERU's x Avg Ac/E			 Ck Outdoor Reqd D Met? (AF / 3.0 A Indoor Need if A (Total AF - D AF): 		
Non-Residential, Indoor/Culinary: (ERV)			- Indoor Need if D (Total AF - D AF):	Shares	
Other/Common Area, Outdoor/Irr: (Ac		AF	- Indoor Need Other: Diff between Ind	oor Need and Owned	
	Total:	AF			
WATER RIGHTS PROPOSED	Owned ¹		Under Co	ontract	
• CUP M&I: (1.0 AF/Sh) Co:	Shares	AF	Shares	AF	
• Daniel: (0.75 AF/Sh) ³	Shares	AF	Shares	AF	
• Extension: (0.3 AF/Sh) ²	Shares	AF	Shares	AF	
• Sage Brush: (0.3 AF/Sh) ²	Shares	AF	Shares	AF	
• Spring Creek: (0.6 AF/Sh)	Shares	AF	Shares	AF	
• Timpanogos, Class A: (1.85 AF/Sh) ²	Shares		Shares	AF	
• Timpanogos, Class D: (3.0 AF/Sh)	Shares	AF	Shares	AF	
• Wasatch: (3.4 AF/Sh)	Shares	AF	Shares	AF	
• Other Water Rights: ChgApp #	55-	AF (ChgApp # <u>55-</u>	AF	Total
	Total:	AF		AF	AF
		%		 %	%

Notes

NOTES AND INFRASTRUCTURE PROPOSED

¹ 100% of water rights for a project/phase must be transferred to City upon Final approval of that project/phase. (Code 15.16.090)

² These shares may only be used for indoor water requirement.

³ Requires approval and beneficial use statement from irrigation company.


HEBER CITY APPROVAL	
HEDER CITT ATTROVAL	
Heber City Engineer - Bart Mumford Date	
By this approval Heber City acknowledges it has reviewed this document and any attached supporting material regard the development's preliminary water right needs and water rights being pledged, and found these documents to be in material compliance with City Code Section 15.16.090. Adjustments may be made prior to time of transfer to City at Final Development Approval as required. This approval does not constitute City acceptance of the development, or	ing

Lability for calculations and transfer of said water rights to Heber City.

AMERICAN EAGLE READY-MIX

CONCRETE PLANT

FINAL APPLICATION

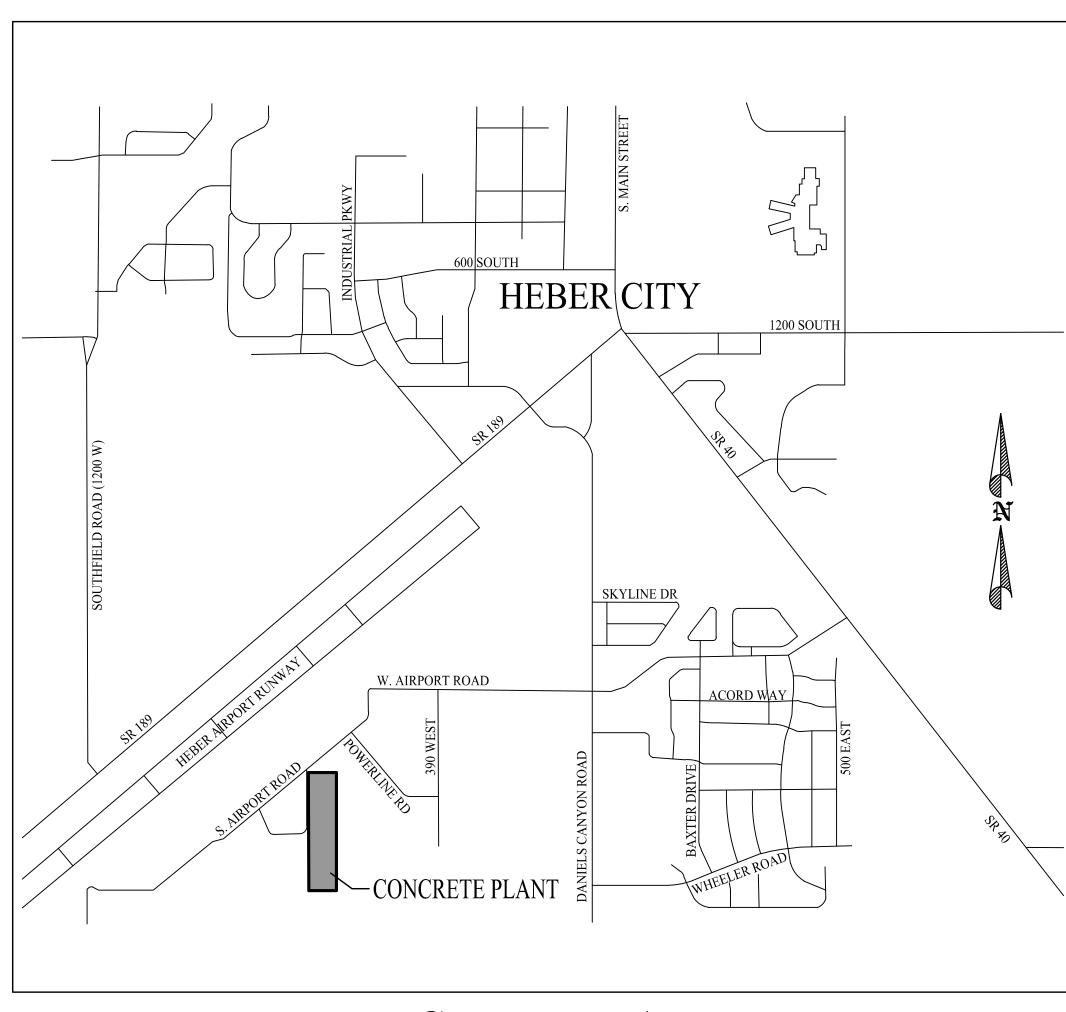

VICINITY MAP

SHEET INDEX

- EXISTING CONDITIONS
- 2. SITE PLAN
- 3. LANDSCAPE PLAN
- SPRINKLER IRRIGATION PLAN
- 5. UTILITY PLAN
- 6. GRADING AND PAVING PLAN
- . STORM DRAIN PLAN
- WATER CONSTRUCTION PLANS
- SEWER CONSTRUCTION DETAILS
- 10. STORM DRAIN DETAILS
- SUBDIVISION PLAT

THIS DOCUMENT IS RELEASED FOR REVIEW ONLY. IT IS NOT INTENDED FOR CONSTRUCTION UNLESS SIGNED AND SEALED. PAUL D. BERG SERIAL NO. <u>295595</u> DATE: 4 MAR 2022

DOUG CLEMENTS AMERICAN EAGLE READY-MIX

COVER SHEET



HEBER CITY ENGINEER APPROVAL

RUSSELL FUNK

DATE

<u>LEGEND</u> ---EXSS --- EXISTING SEWER ——EXW —— EXISTING WATER ---EXIRR--- EXISTING PRESSURIZED IRRIGATION

EXISTING OVERHEAD POWER LINE TO BE PLACED UNDERGROUND WITH PROJECT

BLUE STAKE NOTE:

LOCATION OF EXISTING UTILITIES SHOWN ON PLAN ARE APPROXIMATE AND MAY BE INCOMPLETE. CONTRACTOR IS RESPONSIBLE FOR BLUE STAKING OF UTILITIES.

EXISTING BUILDING REMOVAL

INSPECTION OF THE EXISTING BUILDING FOR HAZARDOUS MATERIALS TO BE COMPLETED BY OWNER PRIOR TO REMOVAL. CONTRACTOR IS RESPONSIBLE FOR PERMITS,


> SERIAL NO. <u>295595</u> DATE: <u>4 MAR 2022</u>

HEBER CITY ENGINEER APPROVAL

RUSSELL FUNK

DATE

AND DISPOSAL OF THE BUILDING.

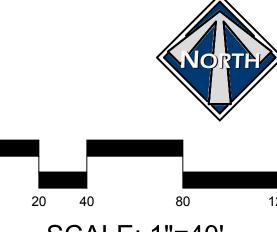

SCALE: 1"=40'

DOUG CLEMENTS AMERICAN EAGLE READY-MIX

THIS DOCUMENT IS RELEASED FOR REVIEW ONLY. IT IS NOT INTENDED FOR CONSTRUCTION UNLESS SIGNED AND SEALED. **EXISTING CONDITIONS** PAUL D. BERG P.E.



DESIGN BY: PDB DATE: 4 MAR 2022 DRAWN BY: RHH REV:


COMMON / BOTANICAL NAME **GROUND COVERS** 2"-4" Xeriscape Cobble Rock / 2"-4" Xeriscape Cobble Rock MULCH COMMON / BOTANICAL NAME 3" Cobble Rock / Cobble Rock Washed Gravel / Gravel


LAND USE TABLE

TOTAL AREA 5.01 ACRES

LANDSCAPED AREAS 1.43 ACRES (28.50%)

SOS GATE NOTE: ALL SOS GATES SHALL BE APPROVED BY THE WASATCH COUNTY FIRE DEPARTMENT PRIOR TO ORDERING THE GATE AND INSTALLATION.

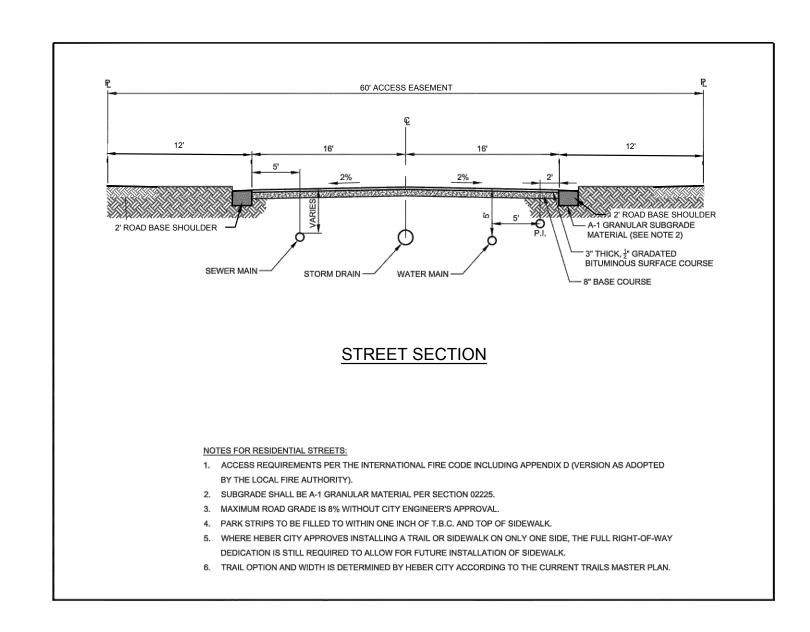

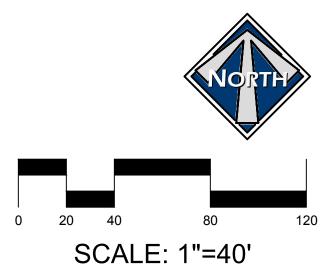

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HEBER CITY ENGINEER APPROVAL DATE


RUSSELL FUNK


DOUG CLEMENTS AMERICAN EAGLE READY-MIX

SITE PLAN



DESIGN BY: PDB DATE: 4 MAR 2022 DRAWN BY: DW

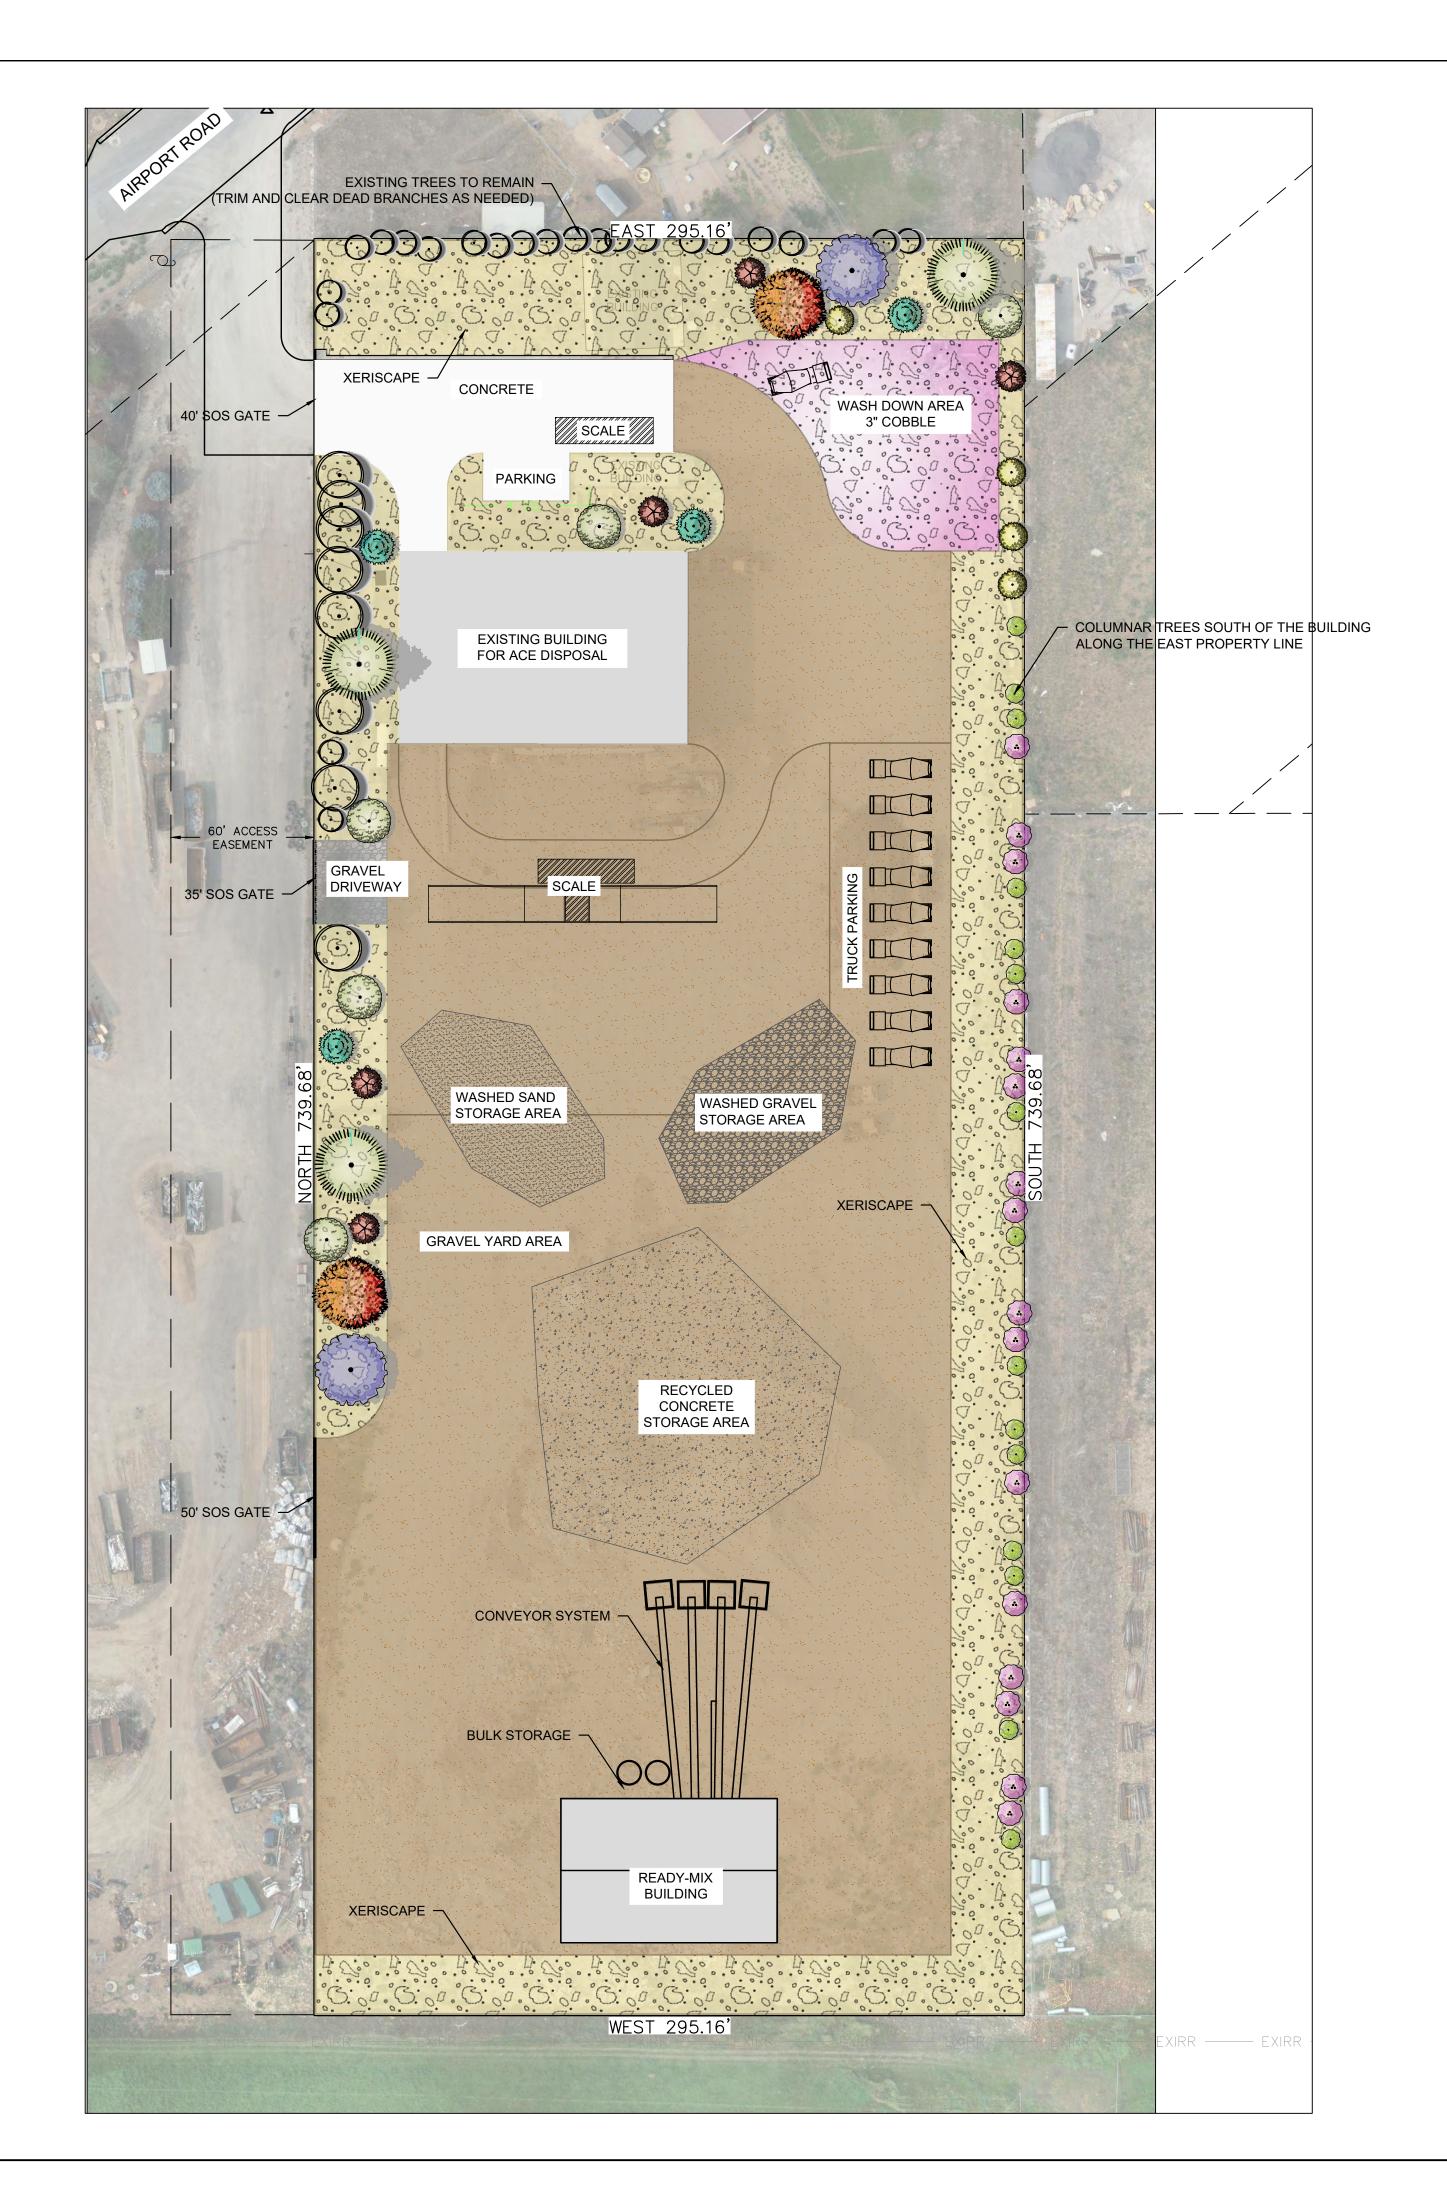

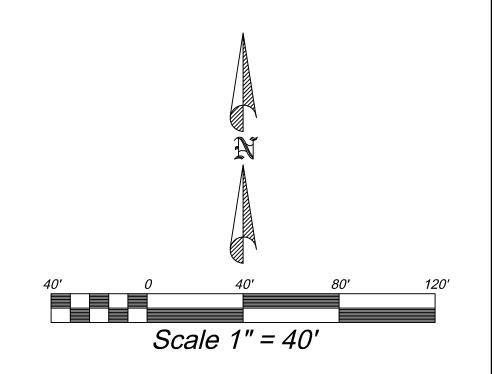

PLANT SCHEDULE TREES	<u>QTY</u>	COMMON / BOTANICAL NAME	CONT	CAL	SIZE
	2	Autumn Blaze Maple / Acer freemanii `Autumn Blaze`	B&B	2" Cal	
	2	Autumn Purple Ash / Fraxinus americana `Autumn Purple`	B&B	2" Cal	
	5	Canada Red Chokecherry / Prunus virginiana `Canada Red`	B&B	2" Cal	
	15	Columnar Green Beech / Fagus sylvatica `Fastigiata`	B&B	2" Cal	
	16	Columnar Purple Beech / Fagus sylvatica `Dawyck Purple`	B&B	2" Cal	
	4	Quaking Aspen / Populus tremuloides	B&B	2" Cal	
	5	Spring Snow Crab Apple / Malus x `Spring Snow`	B&B	2" Cal	
EVERGREEN TREES	QTY	COMMON / BOTANICAL NAME	CONT	CAL	SIZE
(0)	4	Black Hills Spruce / Picea glauca `Densata`	B&B		6`-7` H
Advantage of the second	3	White Fir / Abies concolor	B&B		8-10`
GROUND COVERS	QTY	COMMON / BOTANICAL NAME	CONT		
	54,715 sf	2"-4" Xeriscape Cobble Rock / 2"-4" Xeriscape Cobble Rock	Mulch		
MULCH	QTY	COMMON / BOTANICAL NAME	CONT		
. (C.)	7,478 sf	3" Cobble Rock / Cobble Rock	Mulch		
	131,727 sf	Washed Gravel / Gravel	Mulch		
\odot	30	Existing Trees to Remain (Trim and clear dead branches as	needed)		

LANDSCAPE NOTES:

- AT LEAST ONE TREE FOR EVERY 50' OF STREET FRONTAGE (MINIMUM OF 15 TREES)
 MINIMUM OF 20% OF LANDSCAPED AREAS SHALL BE PLANTER BEDS, CONTAINING OF
- ROCK OR BARK MULCH, TREES, SHRUBS, AND ORNAMENTAL GRASSES.
- MINIMUM OF 40% OF ALL LANDSCAPED AREAS SHALL BE COVERED WITH PLANTED VEGETATION.

LAND USE TABLE

TOTAL AREA 5.01 ACRES

LANDSCAPED AREAS 1.43 ACRES (28.50%)

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CARL N. BERG PLA

SERIAL NO. 7162790

DATE: 4 MAR 2022

HEBER CITY ENGINEER APPROVAL


RUSSELL FUNK DATE

DOUG CLEMENTS AMERICAN EAGLE READY-MIX

LANDSCAPE PLAN




DESIGN BY: PDB DATE: 4 MAR 2022 SI DRAWN BY: RHH REV:

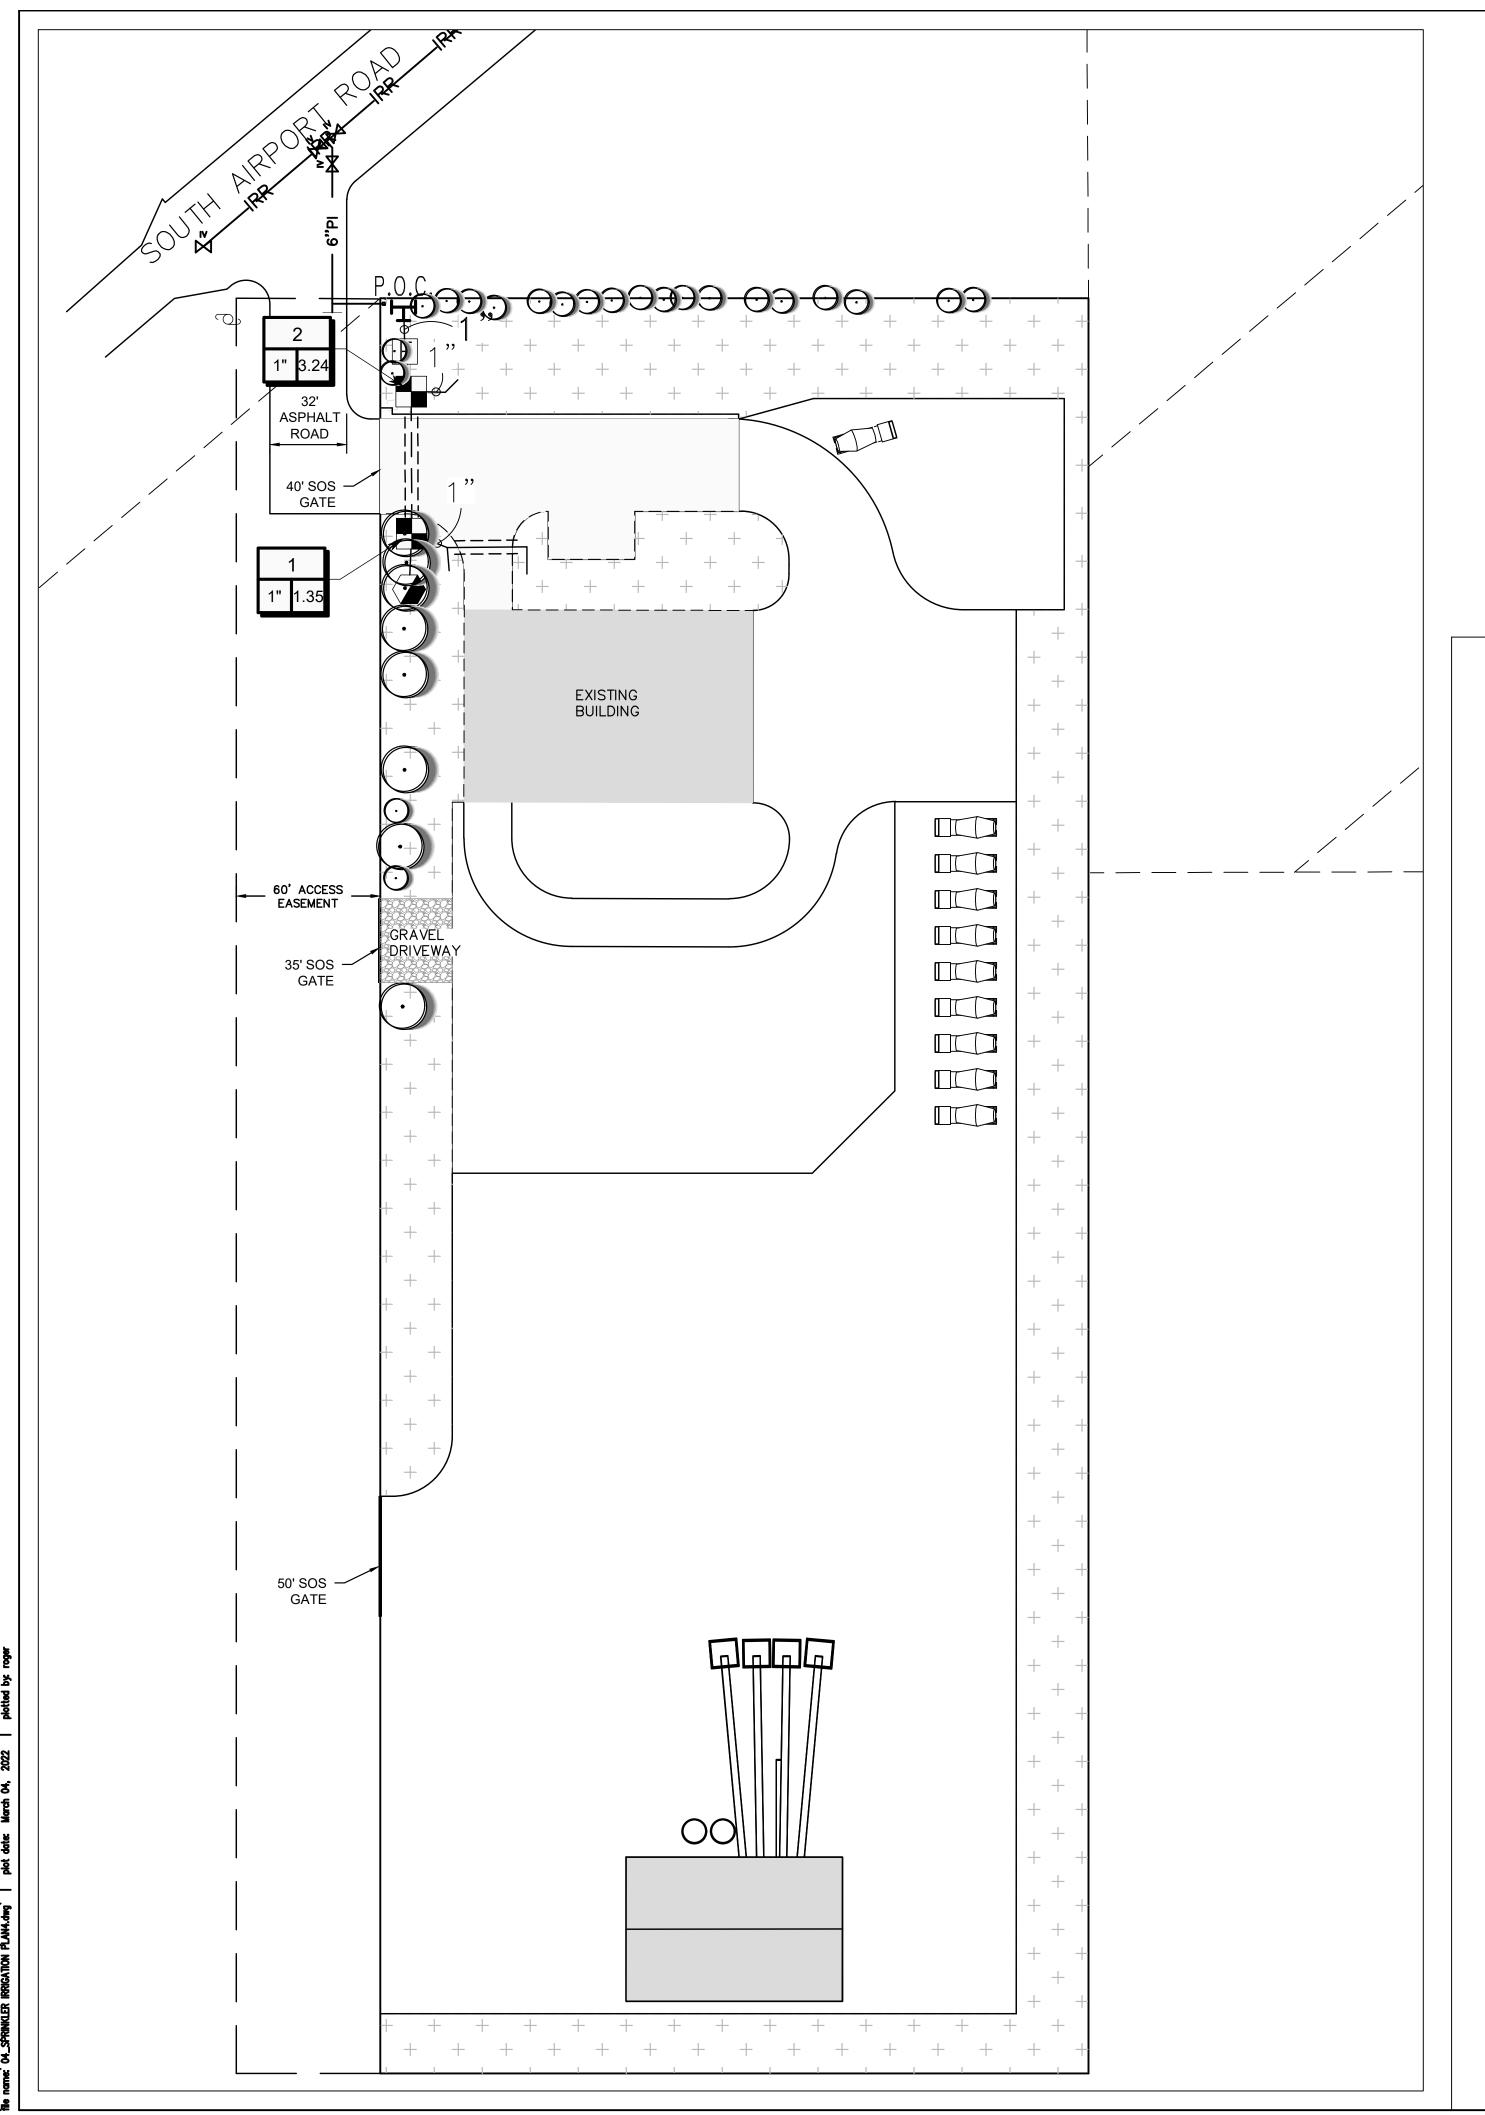


INCOMPLETE. CONTRACTOR IS RESPONSIBLE

FOR BLUE STAKING OF UTILITIES.

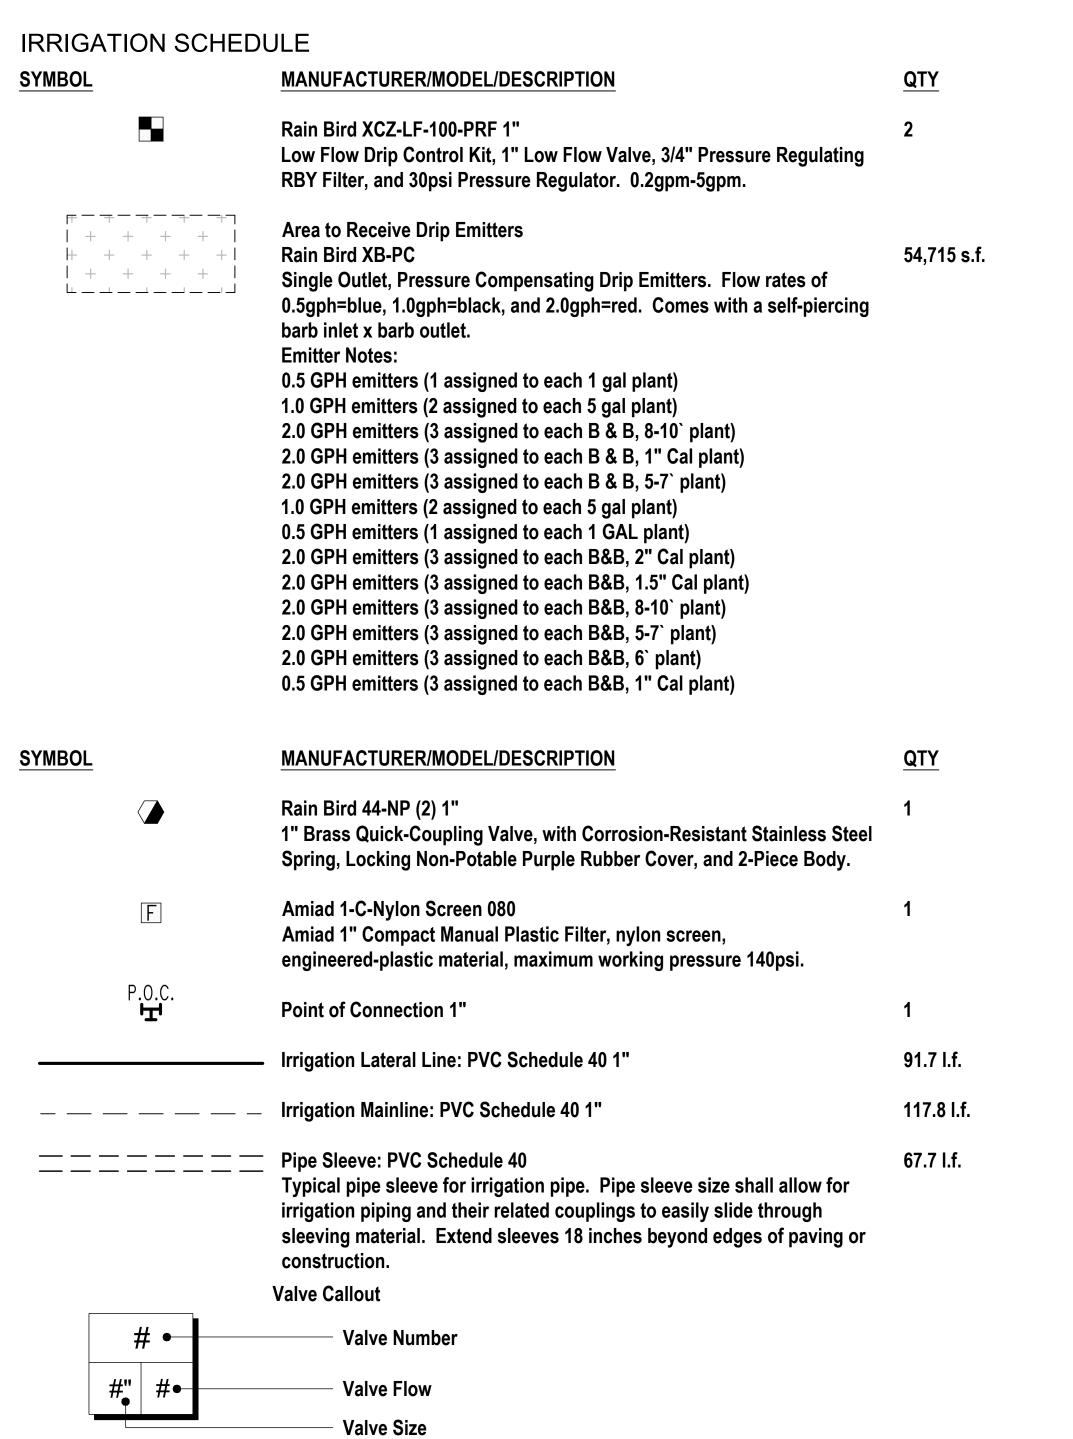



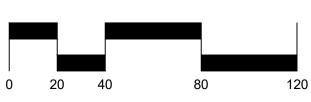

SCALE: 1"=40'

DOUG CLEMENTS AMERICAN EAGLE READY-MIX

SPRINKLER IRRIGATION PLAN

LANDSCAPE ARCHITECTS 380 E Main St, Suite 204

HEBER CITY ENGINEER APPROVAL

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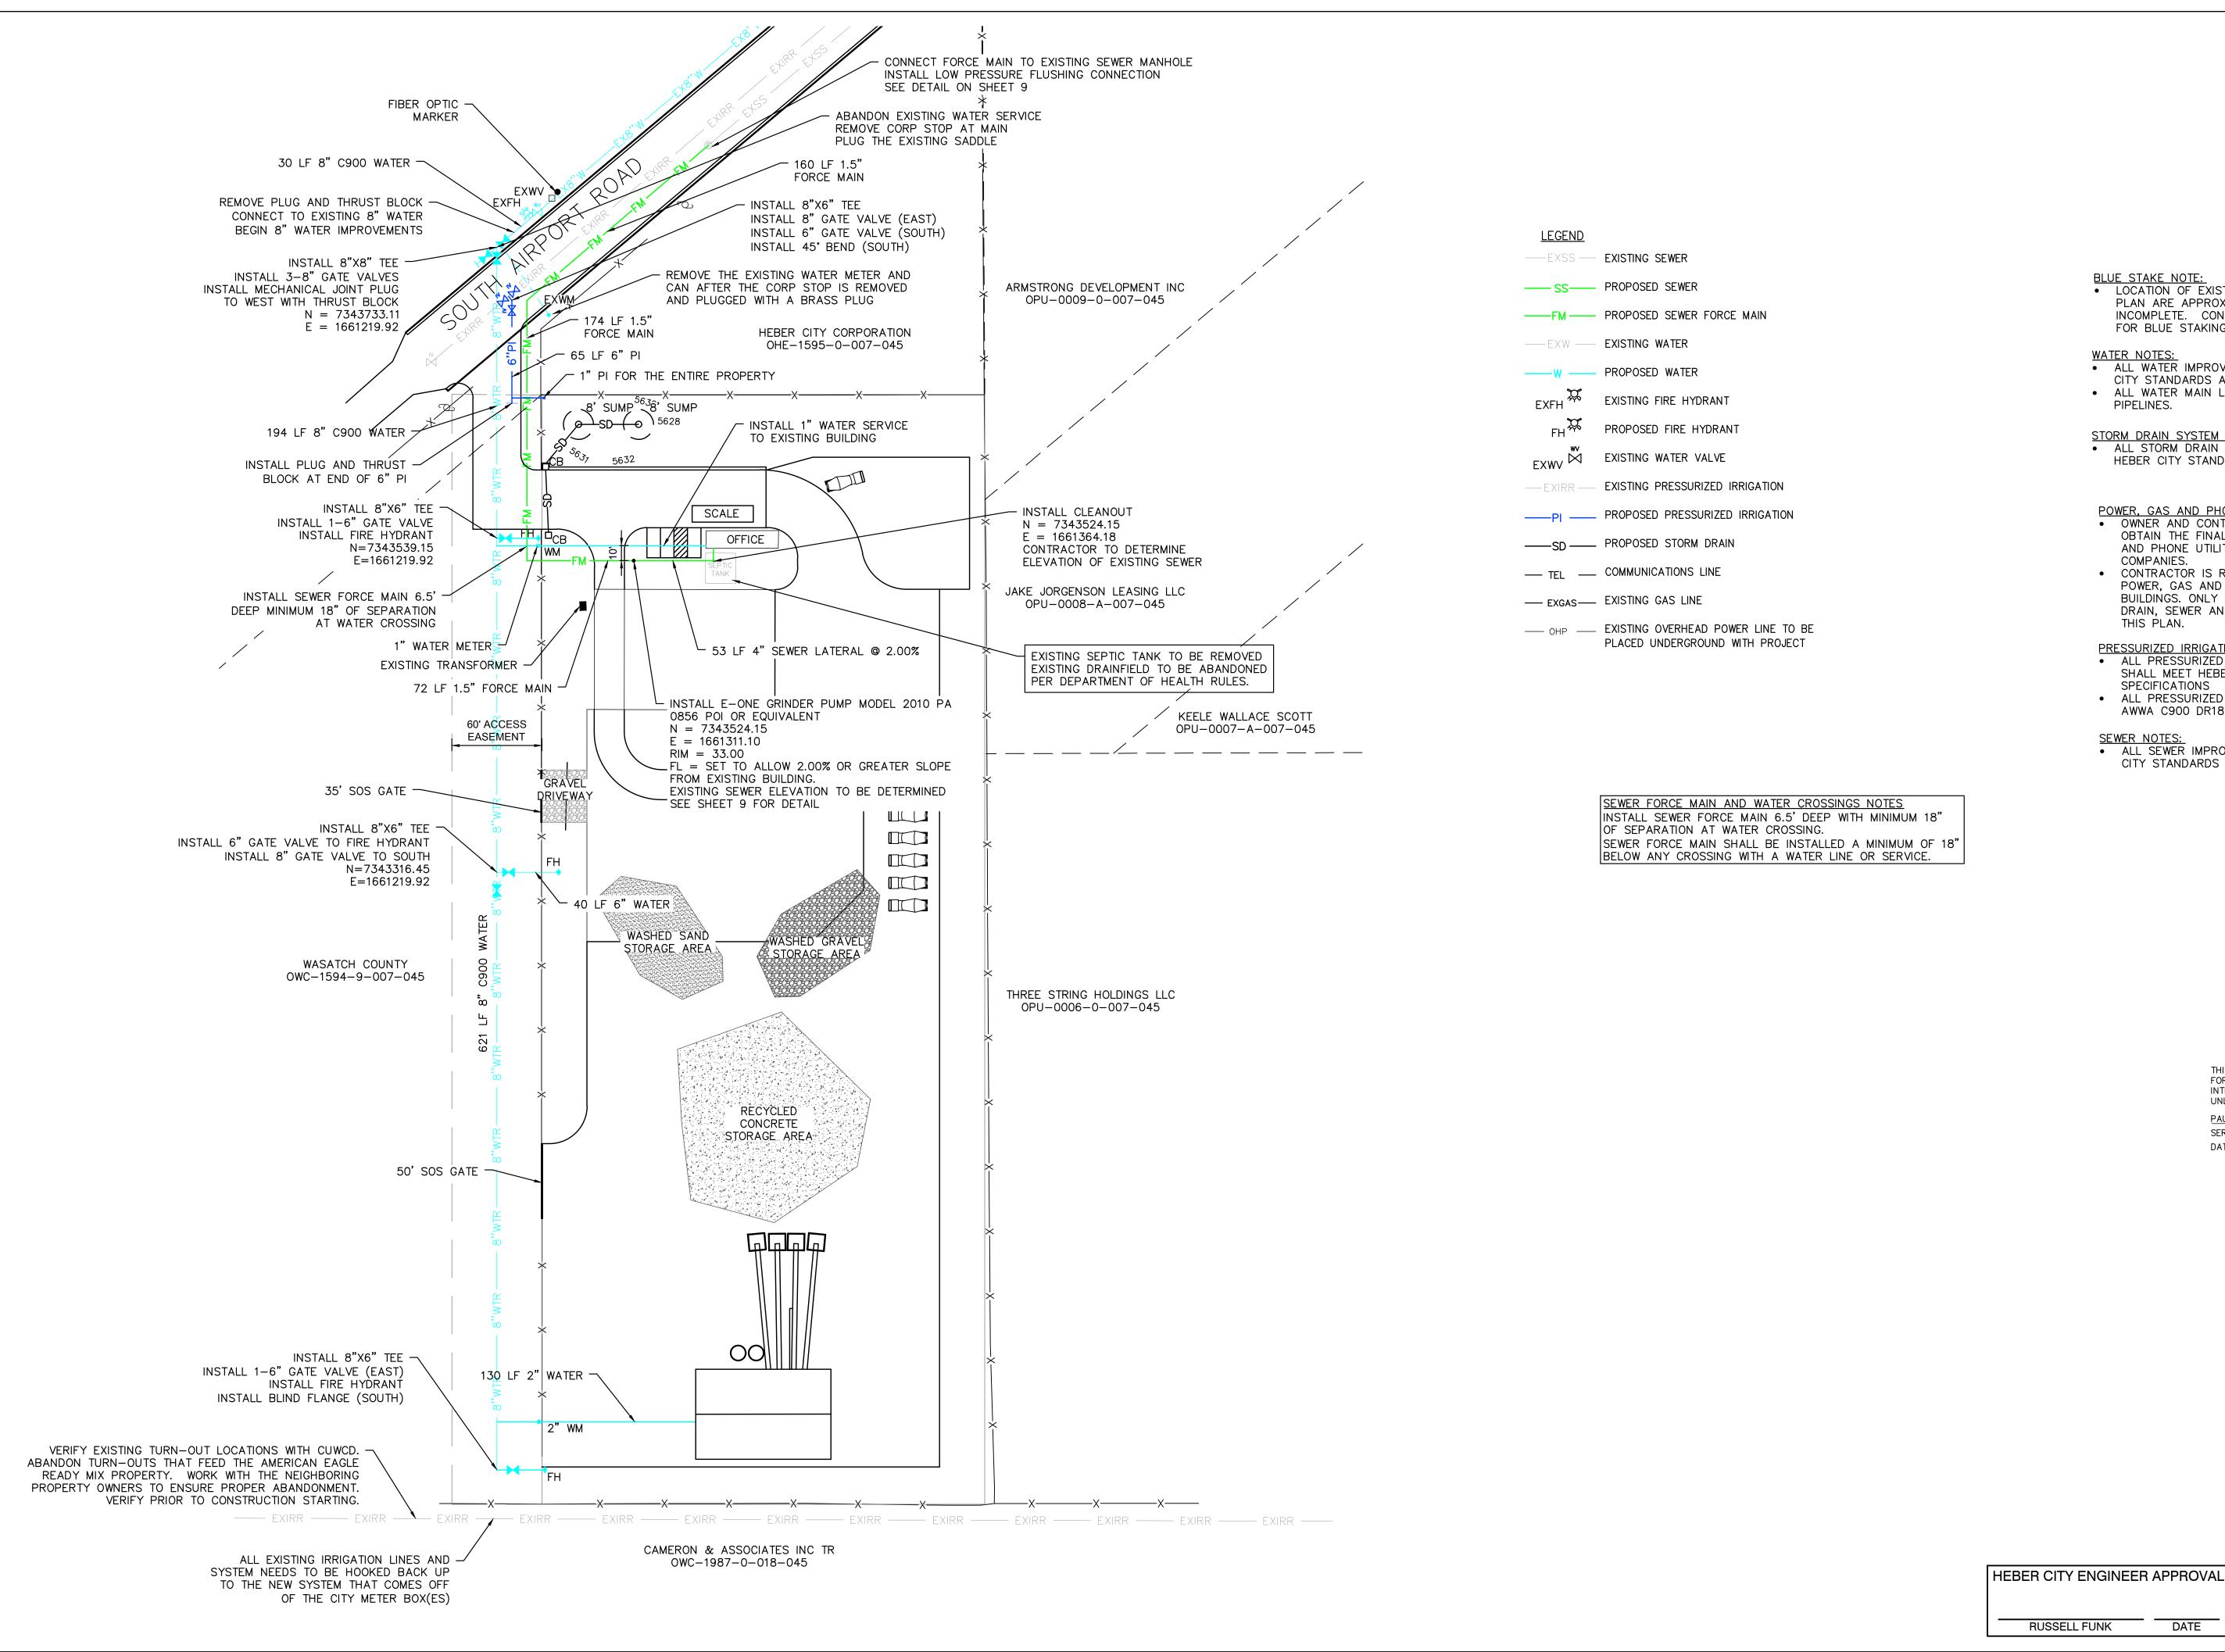
CARL N. BERG PLA

SERIAL NO. <u>7162790</u> DATE: <u>4 MAR 2022</u>

RUSSELL FUNK DATE

380 E Main St, Suite 204
Midway, Ut 84049 ph. (801) 723-2000

DESIGN BY: PDB DATE: 4 MAR 2022 SHEE
DRAWN BY: DW REV: 4



BLUE STAKE NOTE:

 LOCATION OF EXISTING UTILITIES SHOWN ON PLAN ARE APPROXIMATE AND MAY BE INCOMPLETE. CONTRACTOR IS RESPONSIBLE FOR BLUE STAKING OF UTILITIES.

 ALL WATER IMPROVEMENTS SHALL MEET HEBER CITY STANDARDS AND SPECIFICATIONS.

ALL WATER MAIN LINES ARE C-900 DR 18

STORM DRAIN SYSTEM NOTE:

• ALL STORM DRAIN CONSTRUCTION TO MEET HEBER CITY STANDARDS.

POWER, GAS AND PHONE NOTE:

- OWNER AND CONTRACTOR ARE RESPONSIBLE TO OBTAIN THE FINAL DESIGN FOR POWER, GAS AND PHONE UTILITIES FROM THE UTILITY
- CONTRACTOR IS RESPONSIBLE TO COORDINATE POWER, GAS AND PHONE UTILITY TRENCHES TO BUILDINGS. ONLY LOCATIONS FOR WATER, STORM DRAIN, SEWER AND IRRIGATION ARE SHOWN ON THIS PLAN.


PRESSURIZED IRRIGATION NOTES:

- ALL PRESSURIZED IRRIGATION IMPROVEMENTS SHALL MEET HEBER CITY STANDARDS AND SPECIFICATIONS
- ALL PRESSURIZED IRRIGATION MAIN SHALL BE AWWA C900 DR18 PURPLE PIPE.

 ALL SEWER IMPROVEMENTS SHALL MEET HEBER CITY STANDARDS AND SPECIFICATIONS

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SERIAL NO. <u>295595</u> DATE: 4 MAR 2022

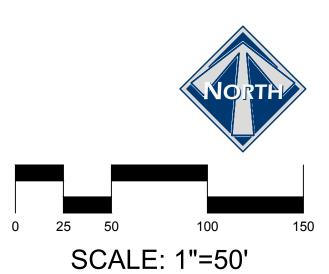


DOUG CLEMENTS AMERICAN EAGLE READY-MIX

UTILITY PLAN



DATE

DESIGN BY: PDB DATE: 4 MAR 2022 DRAWN BY: RHH | REV:

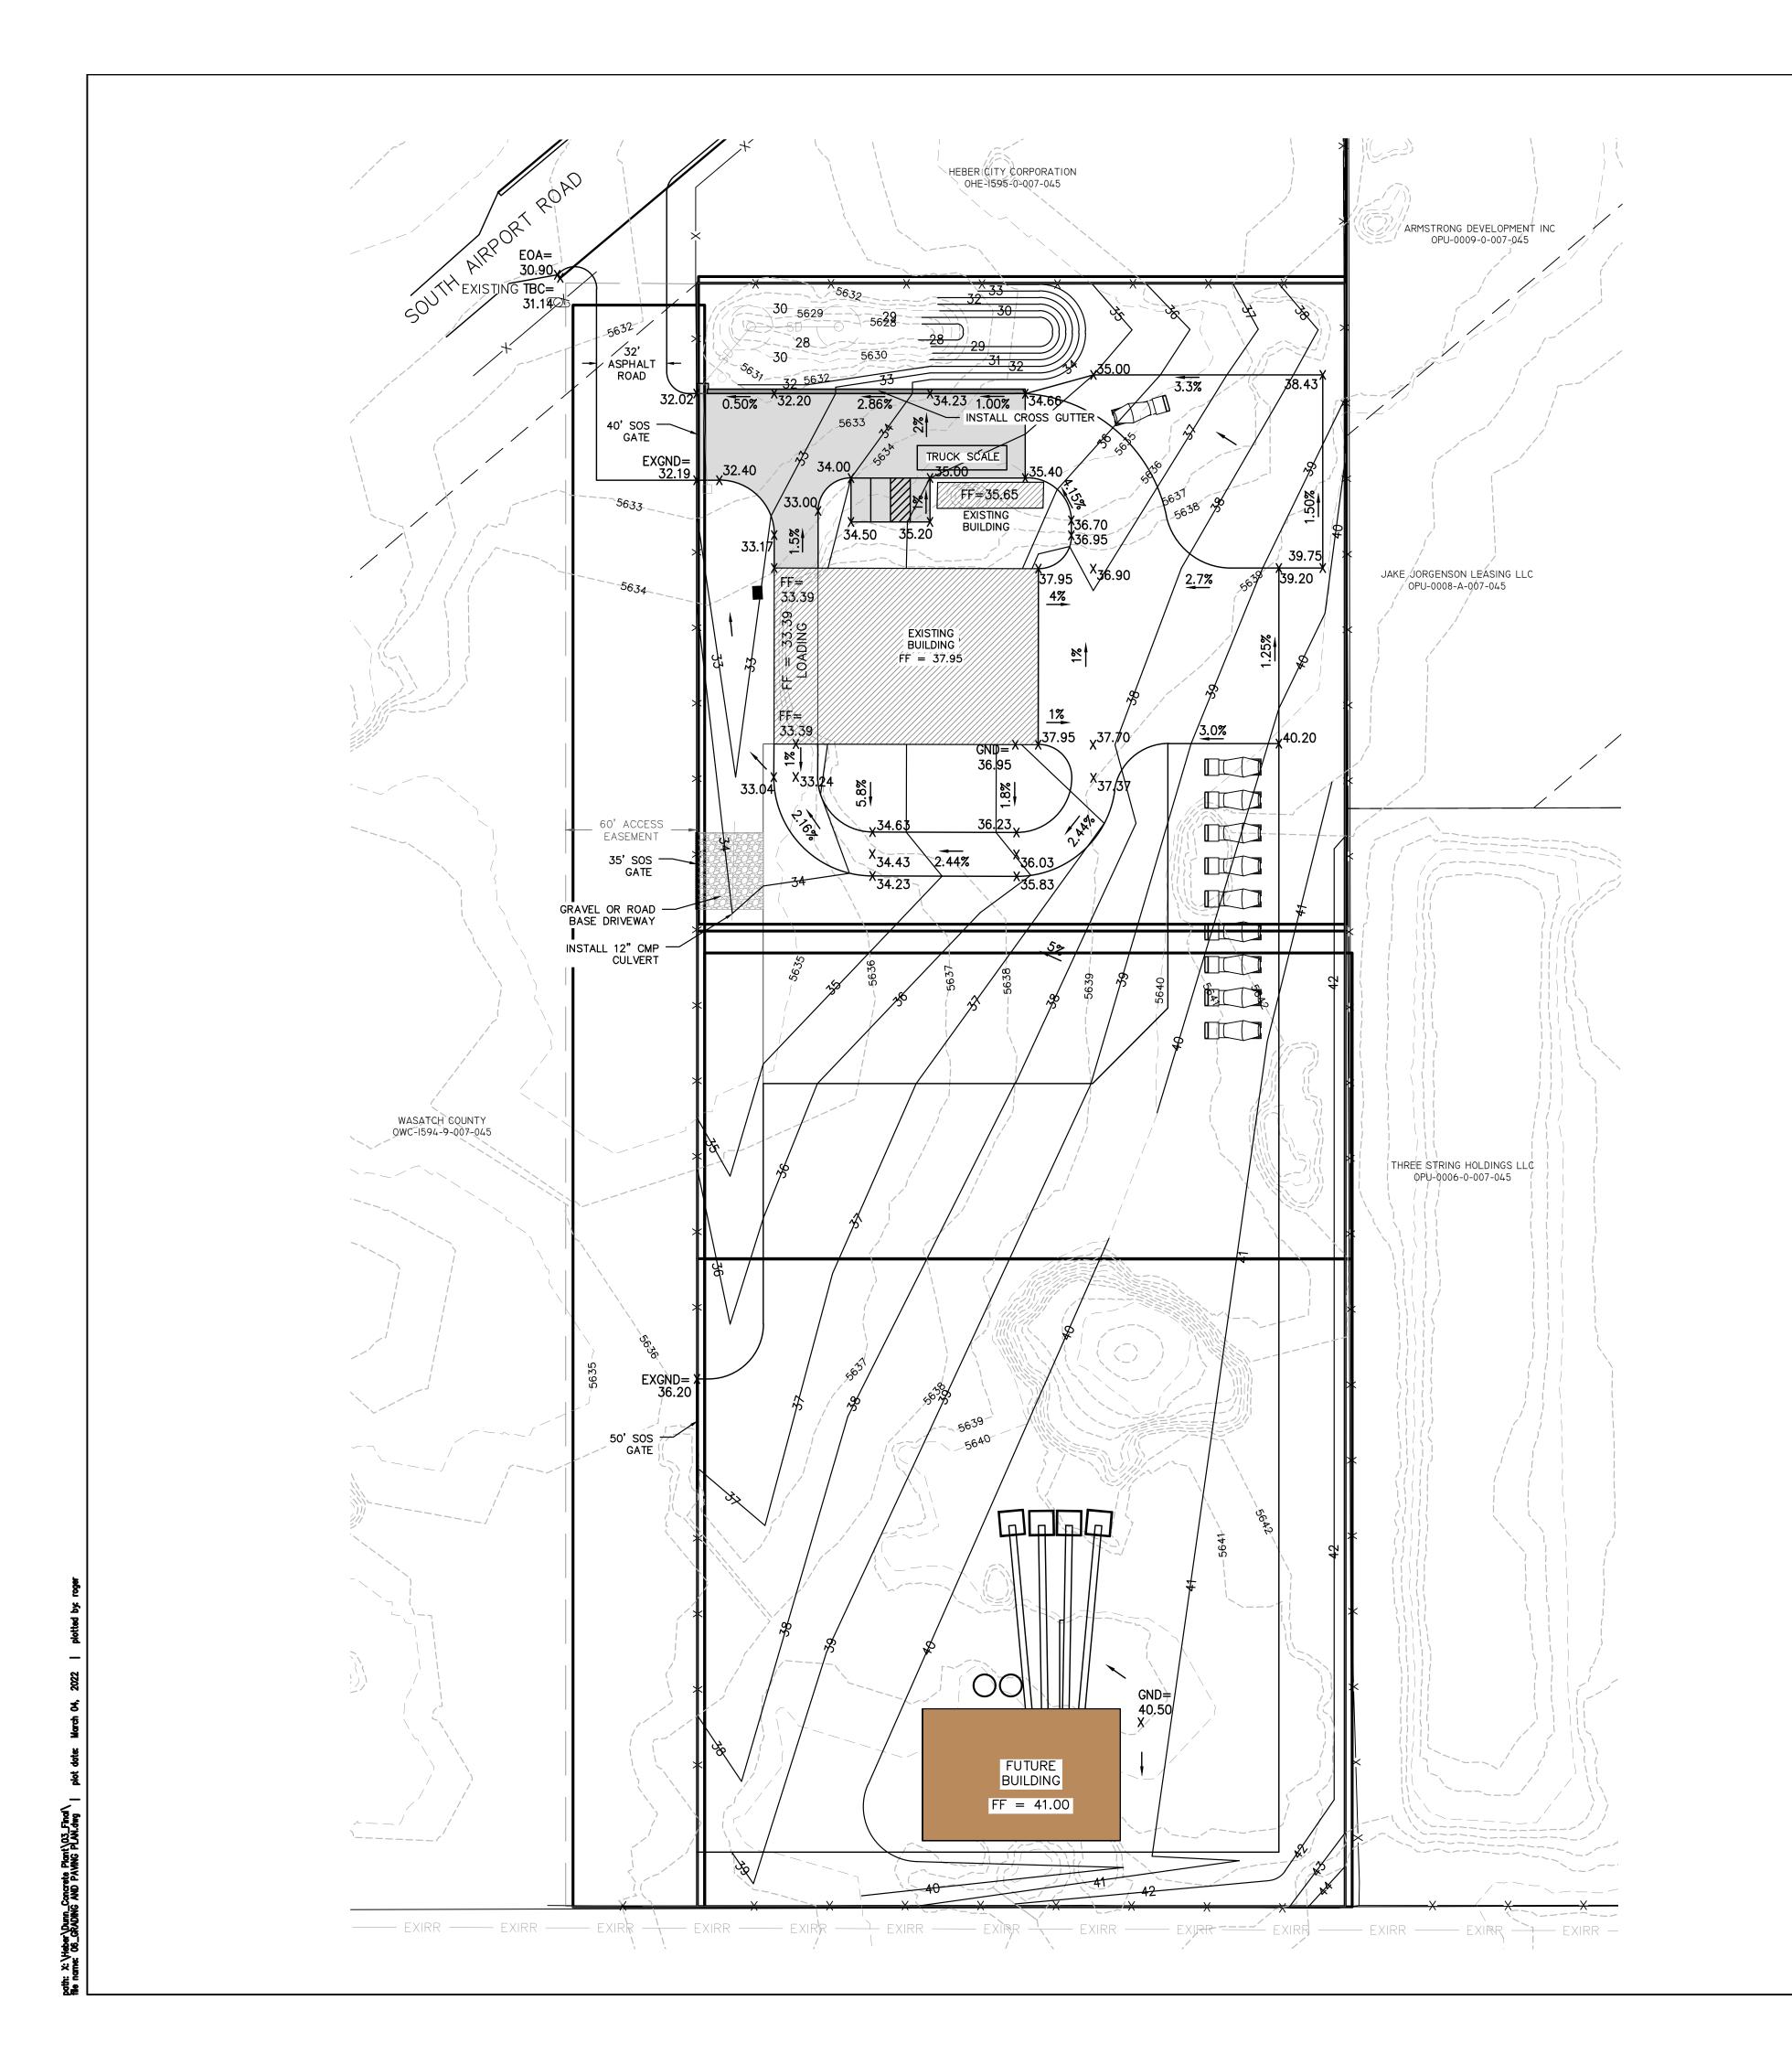

<u>LEGEND</u>

PROPOSED STORM DRAIN SPOT ELEVATION FINISHED FLOOR

EXISTING EDGE OF ASPHALT

PROPOSED BUILDING

GROUND ELEVATION TOP BACK OF CURB

CONCRETE PAD EXISTING BUILDING BLUE STAKE NOTE:

• LOCATION OF EXISTING UTILITIES SHOWN ON PLAN ARE APPROXIMATE AND MAY BE INCOMPLETE. CONTRACTOR IS RESPONSIBLE FOR BLUE STAKING OF UTILITIES.

NOTES:
1. CONTRACTOR TO CONFIRM USE OF THE EXISTING FOUNDATION AS A FOUNDATION WALL FOR GRADING PURPOSES WITH THE STRUCTURAL ENGINEER.

2. GRADING TO COMPLY WITH RECOMMENDATION IN

THE GEOTECH REPORT.

3. ALL PAVING AND GRADING IMPROVEMENTS TO COMPLY WITH HEBER CITY SPECIFICATIONS.


NO. 4 @ 10 1/2" BOTH WAYS 12" GRANULAR MATERIAL -CROSS GUTTER

> 7.5" PORTLAND CEMENT CONCRETE PROPERLY PREPARED SUBGRADE -SEE GEOTECH RECOMMENDATIONS FOR CONCRETE JOINT REQUIREMENTS

> > CONCRETE SECTION

6" OF GRAVEL OR ROAD BASE ─ PROPERLY PREPARED SUBGRADE **GRAVEL SECTION**

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SCALE: 1"=40'

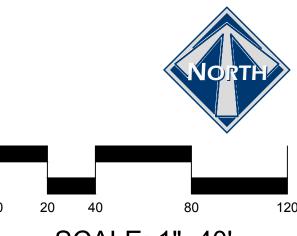
DOUG CLEMENTS AMERICAN EAGLE READY-MIX


GRADING AND PAVING PLAN



HEBER CITY ENGINEER APPROVAL DATE RUSSELL FUNK

DESIGN BY: PDB DATE: 4 MAR 2022 DRAWN BY: RHH REV:

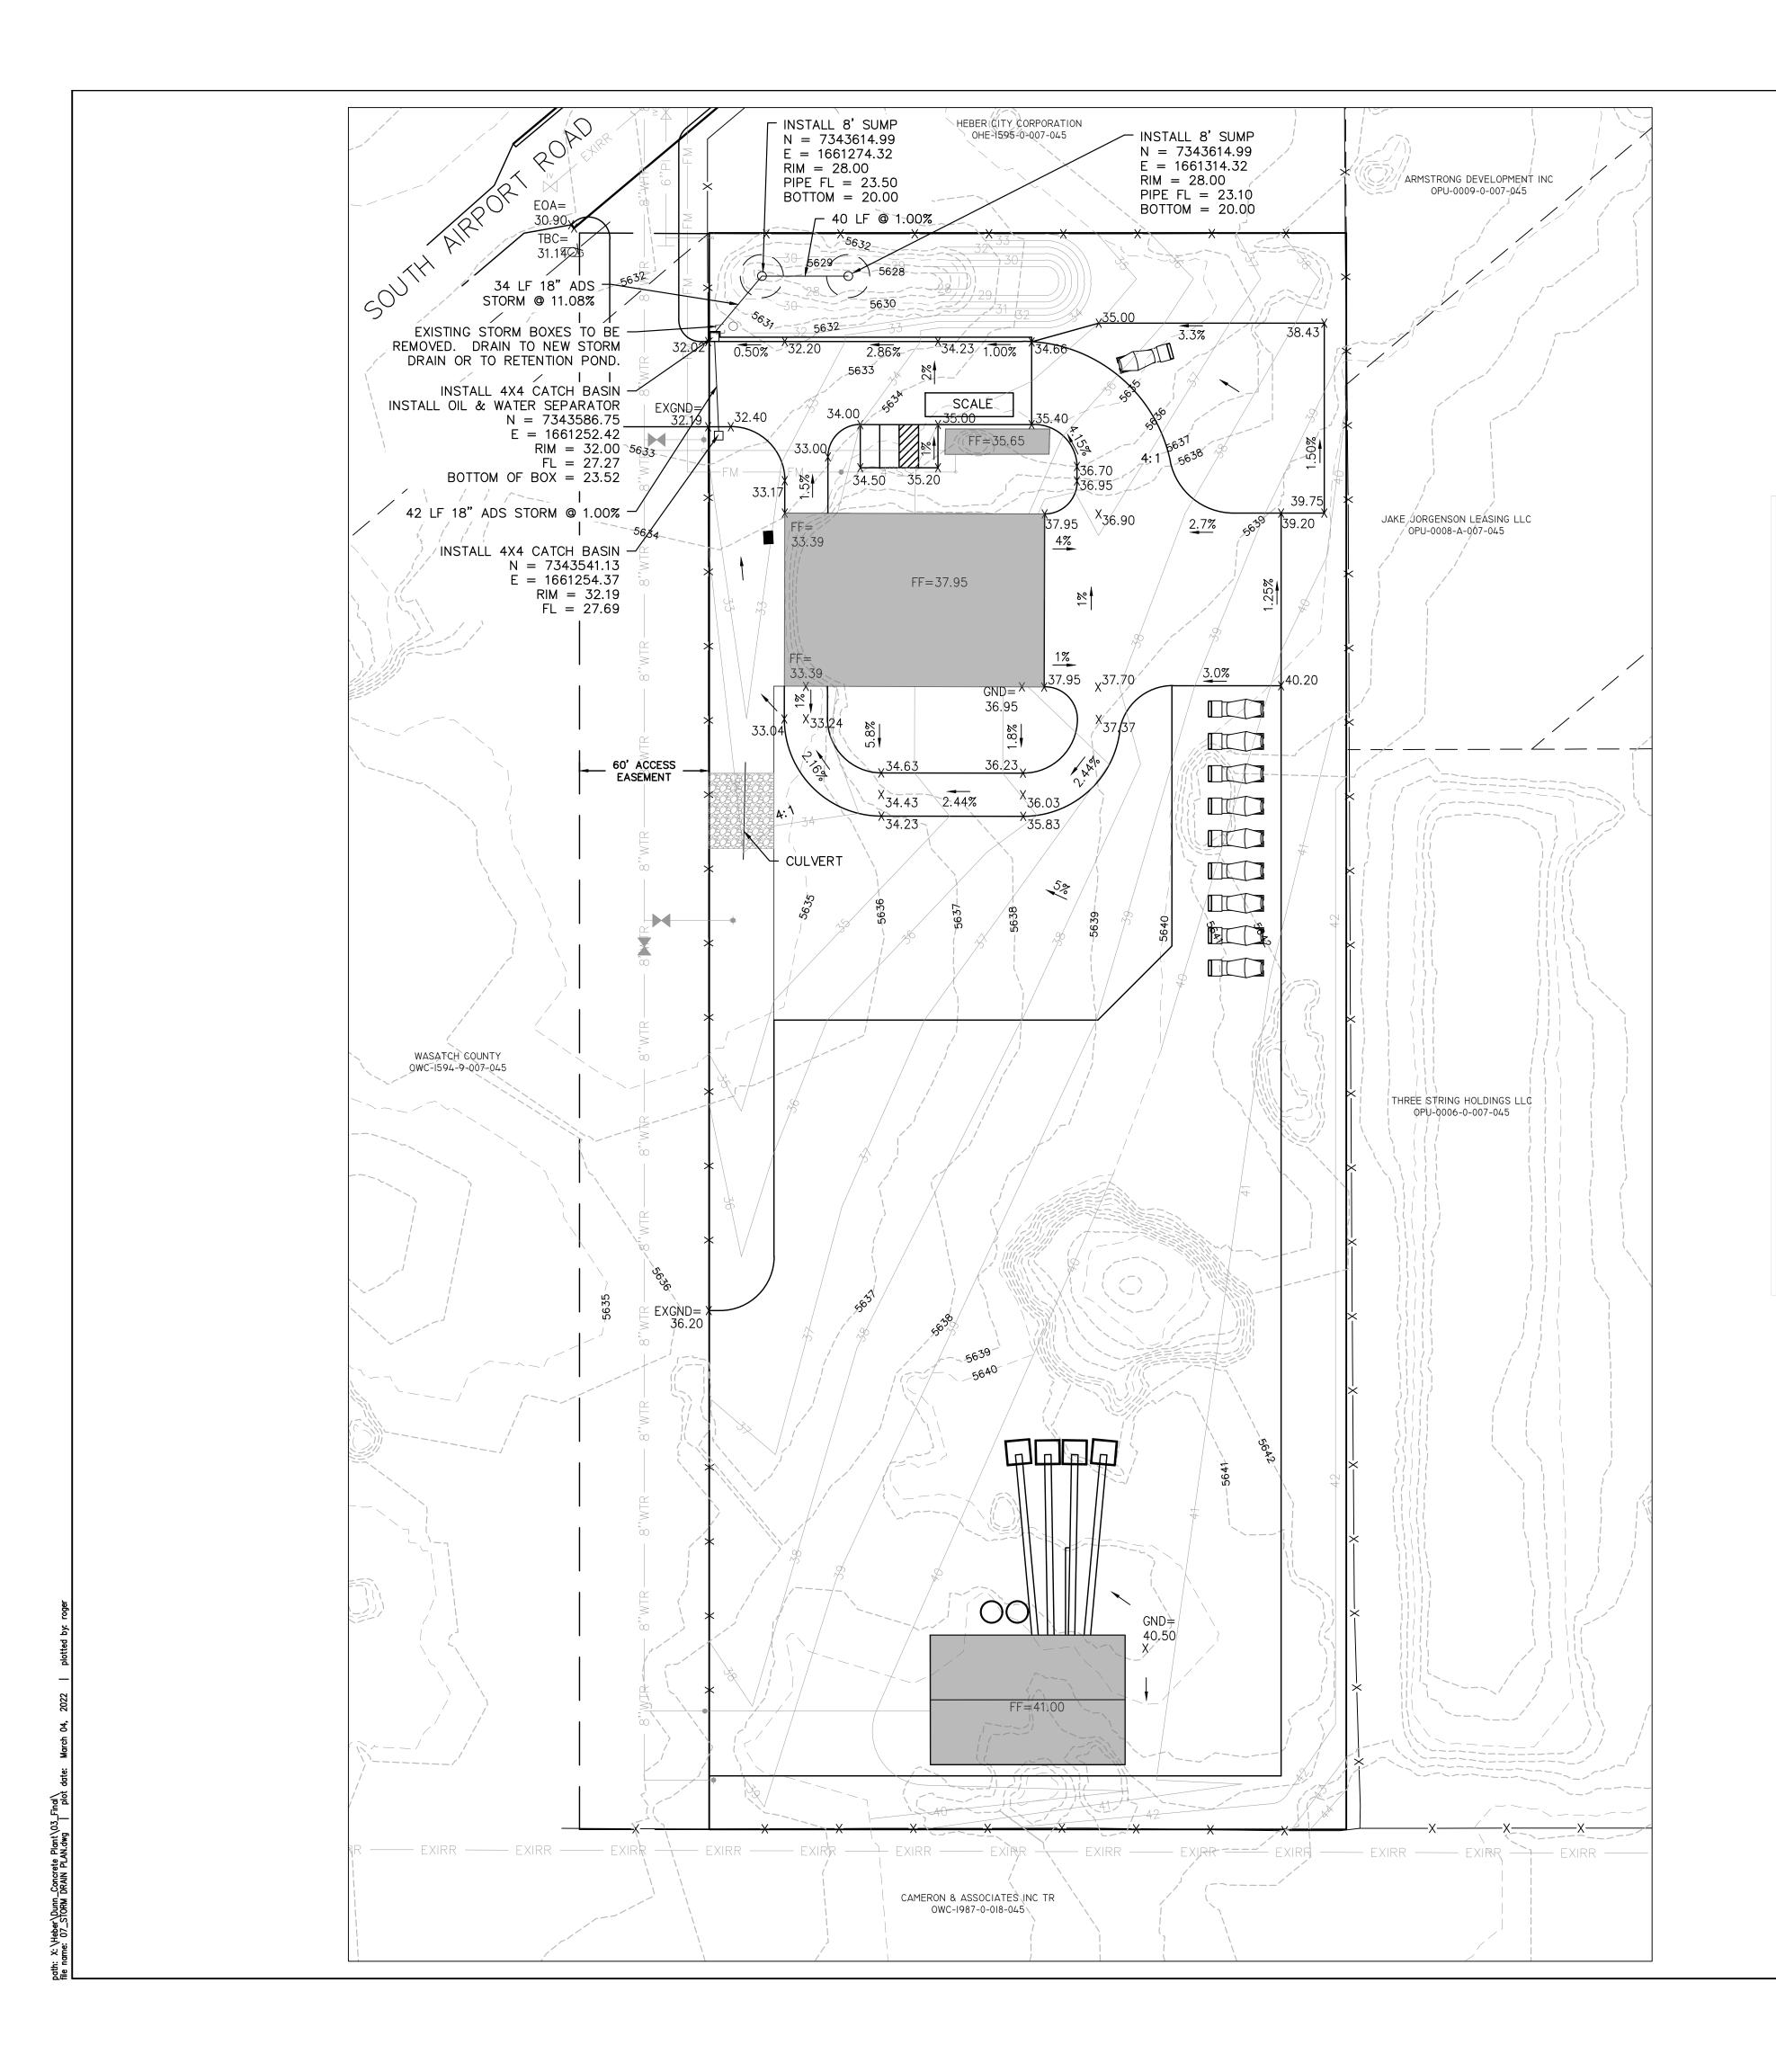

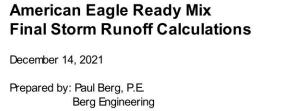

C = 0.95C = 0.90C = 0.30C = 0.15Drainage Total Compsite Runoff Collected Gravel Xeriscape Concrete Area **Driveways** Coefficient

Time	Rainfall	Drainage	Developed Runoff	Peak Runoff	Total Runoff
Period	Intensity	Area	Coefficient	Rate	Volume
(min)	(in / hr)	(acres)		(cfs)	(cf)
15	4.08	5.01	0.33	6.75	6,075
30	2.76	5.01	0.33	4.57	8,220
60	1.71	5.01	0.33	2.83	10,185
120	0.96	5.01	0.33	1.59	11,436
180	0.65	5.01	0.33	1.08	11,615
360	0.35	5.01	0.33	0.58	12,508
720	0.21	5.01	0.33	0.35	15,010
1440	0.13	5.01	0.33	0.22	18,583

- A percolation rate of greater than 60 inches per hour was determine by AGEC.
- A percolation rate of 23 inches per hour was used for design.
- 8' sump has a percolation rate of 0.278 cfs with a soils percolation rate of 23 inches per hour. 8' sump has a volume of 855 cf.

	Total	Design	2-8'	Percolation	Total	Retention
Time	Runoff	Percolation	Sump	from	Sump	Storage Neede
Period	Volume	Rate	Volume	Sump	Capacity	in Pond
(min)	(cf)	(inch / hour)	(cf)	(cf)	(cf)	(cf)
15	6,075	23.0	1,710	500	2,210	3,865
30	8,220	23.0	1,710	1,001	2,711	5,509
60	10,185	23.0	1,710	2,002	3,712	6,474
120	11,436	23.0	1,710	4,003	5,713	5,723
180	11,615	23.0	1,710	6,005	7,715	3,900
360	12,508	23.0	1,710	12,010	13,720	0
720	15,010	23.0	1,710	24,019	25,729	0
1440	18,583	23.0	1,710	48,038	49,748	0

⊟evation	Pond Depth	Pond Area	Pond Volume	Pond Volume	
	(ft)	(sf)	(cf)	(acre-ft)	
5628	0.0	761	0	0.00	
5629	1.0	2,063	1,412	0.03	
5630	2.0	3,168	4,028	0.09	
5631	3.0	4,480	7,852	0.18	Holds 100 year - 24 hour storm
5632	4.0	5,922	13,053	0.30	1' of freeboard

<u>LEGEND</u>

---EXSS-- EXISTING SEWER PROPOSED SEWER

EXISTING WATER PROPOSED WATER

EXISTING PRESSURIZED IRRIGATION PROPOSED PRESSURIZED IRRIGATION

PROPOSED STORM DRAIN

BUILDING FOOTPRINT

BLUE STAKE NOTE:

• LOCATION OF EXISTING UTILITIES SHOWN ON PLAN ARE APPROXIMATE AND MAY BE INCOMPLETE. CONTRACTOR IS RESPONSIBLE FOR BLUE STAKING OF UTILITIES.

STORM DRAIN NOTES: ALL STORM DRAIN CONSTRUCTION TO

MEET HEBER CITY STANDARDS.

• ALL STORM WATER FROM THE PROPERTY WILL BE COLLECTED IN THE RETENTION POND AT

THE NORTH END OF THE PROPERTY. DRAINAGE SWALE ALONG WEST PROPERTY LINE TO REMAIN AT ALL TIMES TO CONVEY DRAINAGE TO THE POND. PROPERTY OWNER SHALL NOT FILL IN SWALE.





SCALE: 1"=40'

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STORM DRAIN PLAN

BERG ENGINEERING 380 E Main St. Suite 204 Midway, Ut 84049 ph 435.657.9749

DATE RUSSELL FUNK


PAUL D. BERG P.E.

SERIAL NO. <u>295595</u>

DATE: 4 MAR 2022

HEBER CITY ENGINEER APPROVAL

DESIGN BY: PDB DATE: 4 MAR 2022 DRAWN BY: RHH REV:

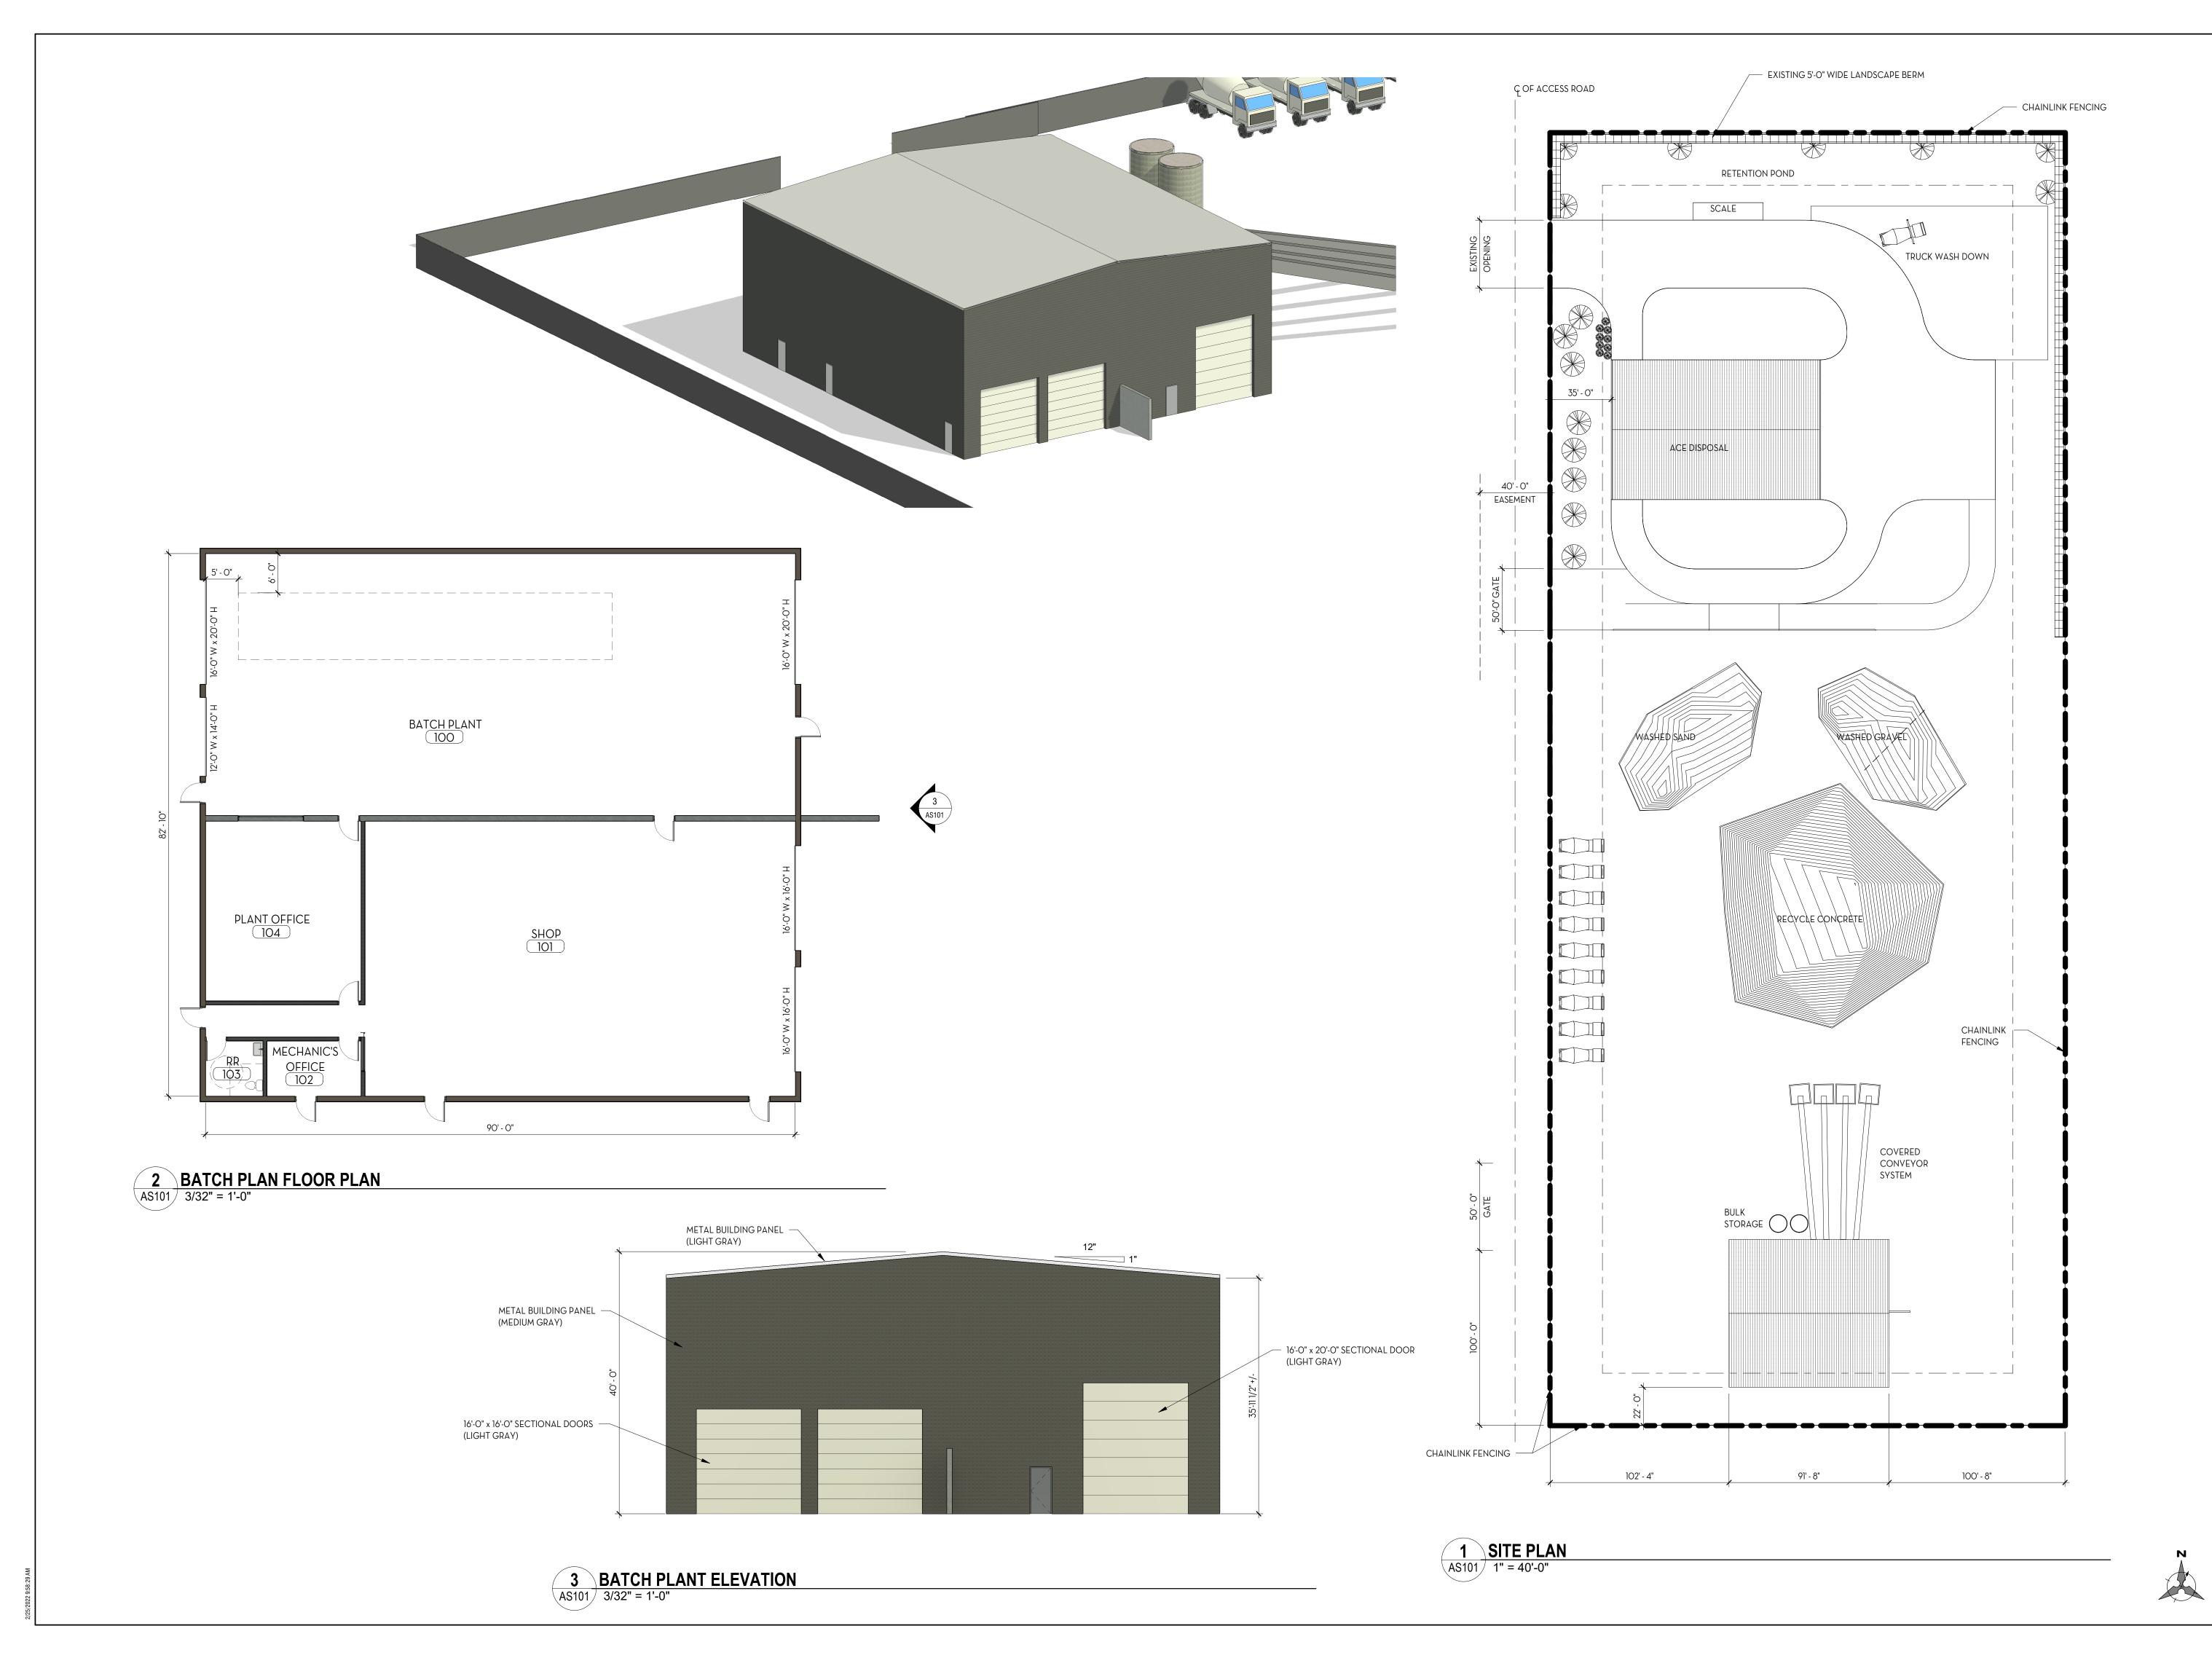



ANDY TONGISH 801-865-0633

PROJECT

AMERICAN EAGLE READY MIX- HEBER

CLIENT

ADDRESS


HEBER CITY, UTAH


=	🕰	$O \mid A$
REVISIO	SNC	
NO.	DATE	DESCRIPTION
-		
ISSUED	:	2/24/2022
PROJE	CT #:	21-008
DRAW	N BY:	act
CHECK	KED BY:	act

SHEET


ARCHITECTURAL SITE PLAN

AS101

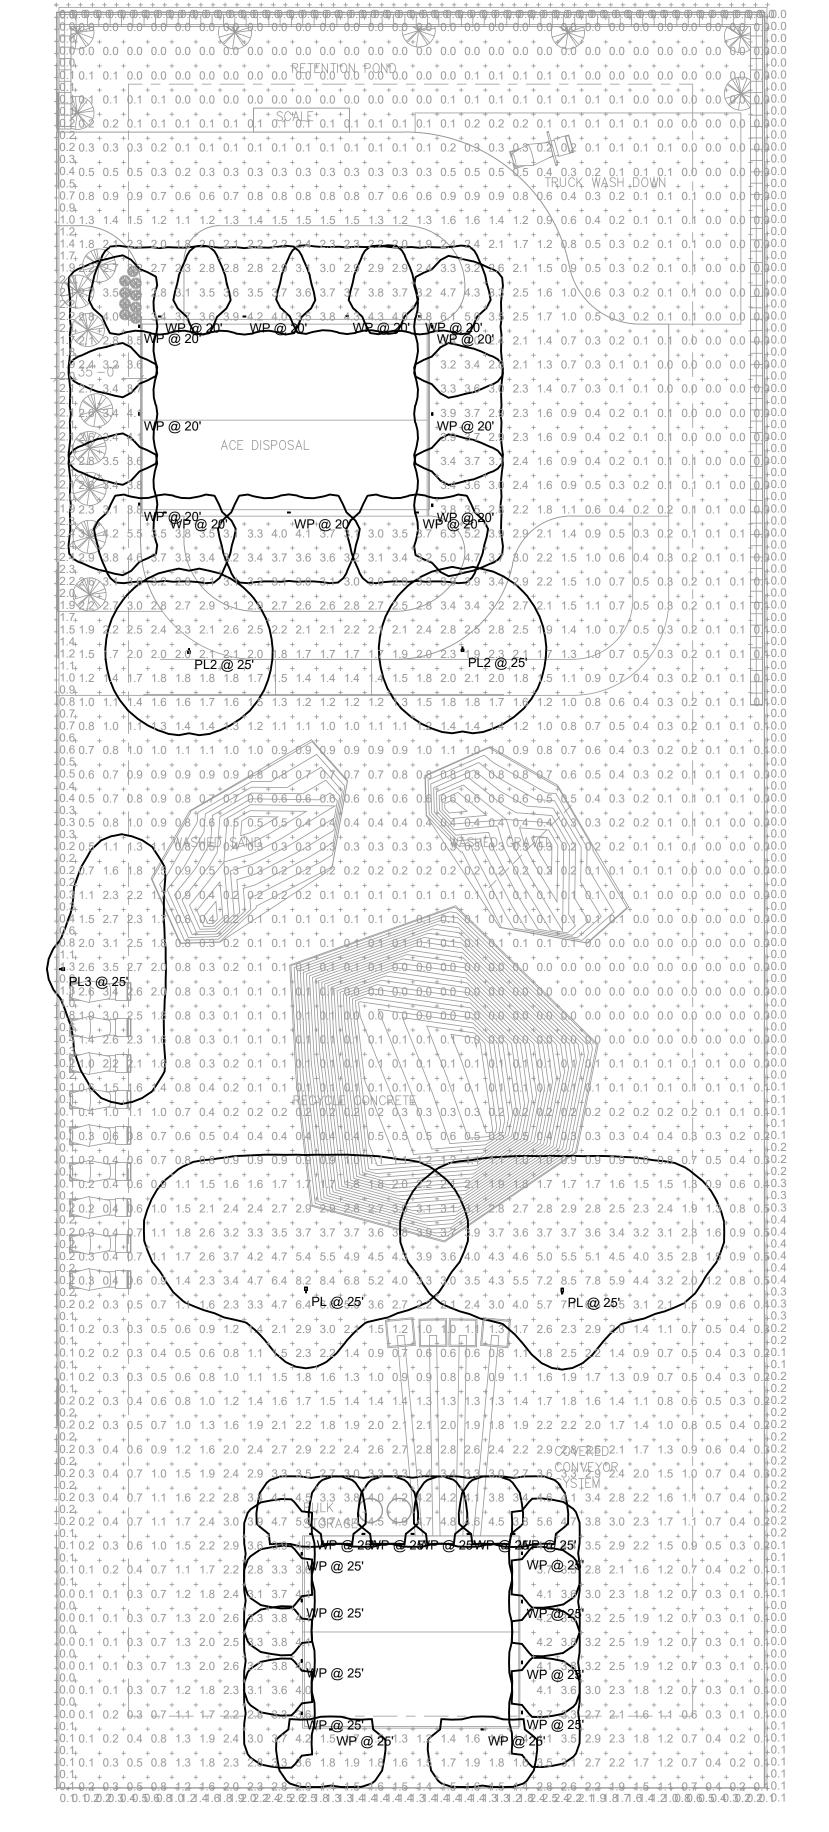


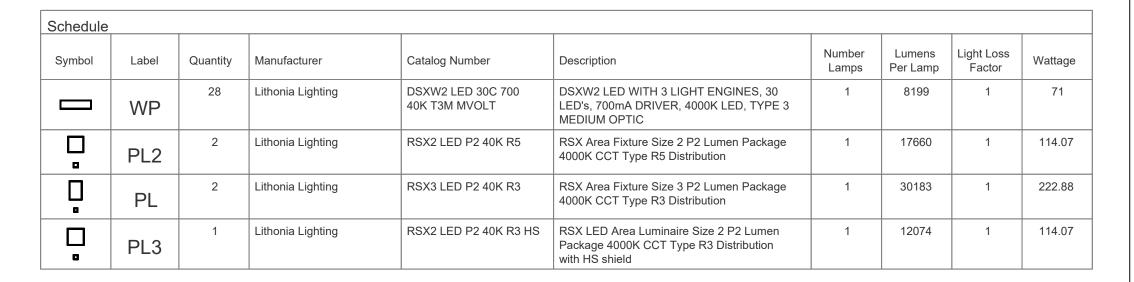

Statistics						
Description	Symbol	Avg	Max	Min	Max/Min	Avg/Mi
Fence Line	+	0.5 fc	2.6 fc	0.0 fc	N/A	N/A
Site	+	1.3 fc	8.5 fc	0.0 fc	N/A	N/A

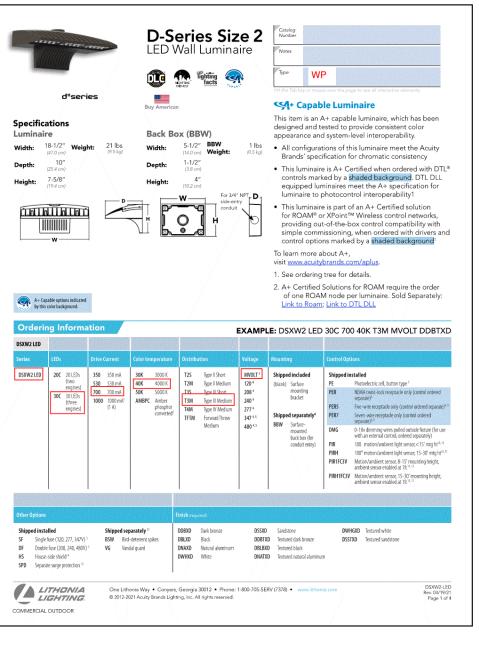



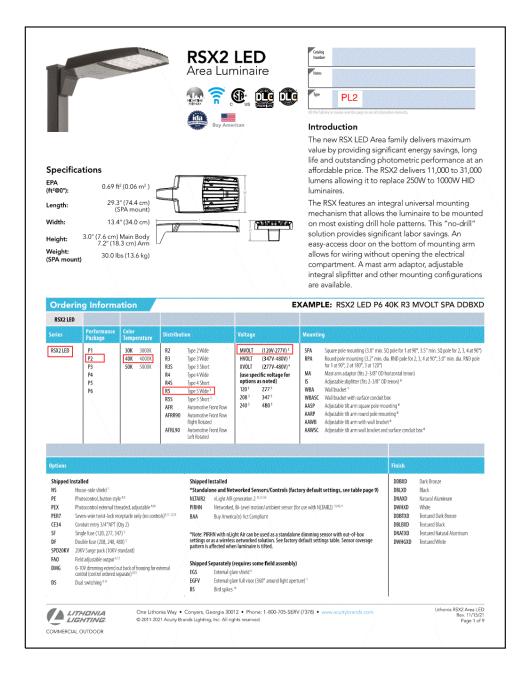





ANDY TONGISH 801-865-0633

-	revision	ns Date	DESC	RIPTION
	TITLE	PROJECT	CLIENT	ADDRESS
	ELECTRICAL SITE PHOTOMETRIC	AMERICAN EAGLE READY MIX- HEBER	AMERICAN EAGLE READY MIX	HEBER CITY, UTAH

2/24/2022

ELECTRICAL SITE

PHOTOMETRIC

21-008

ISSUED:

PROJECT #:

DRAWN BY:

CHECKED BY:

ELECTRICAL SITE PHOTOMETRIC - FOR REFERENCE ONLY

 $\overline{\text{ES}}100$ | SCALE: 1" = 40'-0"

