

LEGEND

=EXISTING ASPHALT

=PROPOSED CONC. SIDEWALK ALONG PUBLIC STREET PROPOSED CONSTRUCTION AREA OF FITNESS WAY PUBLIC STREET



Know what's below. Call before you dig.

PROPERTY LOCATION

THE PROPERTY IS LOCATED WEST OF MOVARA ALONG THE SOUTH RIGHT-OF-WAY LINE OF HIGHWAY 91 AND ALONG THE NORTH RIGHT-OF-WAY LINE OF FITNESS WAY IVINS, UTAH

PROPERTY ADDRESS

KANTA VILLAGE 343 WEST HIGHWAY 91 IVINS, UT 84738

PARCEL ACREAGE

397,312 SQ. FT. - 9.12 ACRES

OWNER/DEVELOPER

OWNER: KAL MALHI OWNER REPRESENTATIVE: MAC BOWELL 17594 WEST AGAVE COURT *GOO*DYEAR, AZ *8*5338 (623) 606-3297

CIVIL ENGINEER

ROB A. REID, P.E. ROSENBERG ASSOCIATES 352 EAST RIVERSIDE DRIVE, SUITE A2 ST. GEORGE, UTAH 84790 (435) 673-8586

GEOTECHNICAL ENGINEER

ARNOLD DECASTRO, P.E. 1420 SOUTH 270 EAST ST. GEORGE, UTAH 84790 (435) 680-6849

SHEET LAYOUT

SHEET NUMBER	SHEET DESCRIPTION
C1.0	COVER SHEET
C1.1	SITE PLAN & SIGNING PLAN
C2.0	GRADING & DRAINAGE PLAN
C2.I	GRADING & DRAINAGE PLAN
C2.2	STORM DRAIN & DRAINAGE IMPROVEMENTS
C2.3	STORM DRAIN & DRAINAGE IMPROVEMENTS
C3.0	UTILITY PLAN - POWER. WATER & SEWER
C3.1	UTILITY PLAN - POWER. WATER & SEWER
C3.2	UTILITY PLAN - GAS TELEPHONE & TV
C3.3	UTILITY PLAN - GAS TELEPHONE & TV
C3.4	UTILITY PLAN - UTILITY NOTES
C4.0	STRIPING PLAN - HIGHWAY 91
C4.1	PLAN FOR PROFILE - FITNESS WAY
C4.2	PROFILE - FITNESS WAY

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5881-18

BaseMap 5881

LMM


DESIGNED BY:

CHECKED BY:

APPROVALS PUBLIC WORKS CITY ENGINEER PARKS & RECREATION LANDSCAPE PLANS \$ IRRIGATION PLANS BUILDING & ZONING PUBLIC SAFETY IVINS IRRIGATION COMPANY CENTURY LINK DOMINION ENERGY ROCKY MOUNTAIN POWER TDS TELECOM POSTMASTER

NOT FOR CONSTRUCTION PLANS NOT
APPROVED

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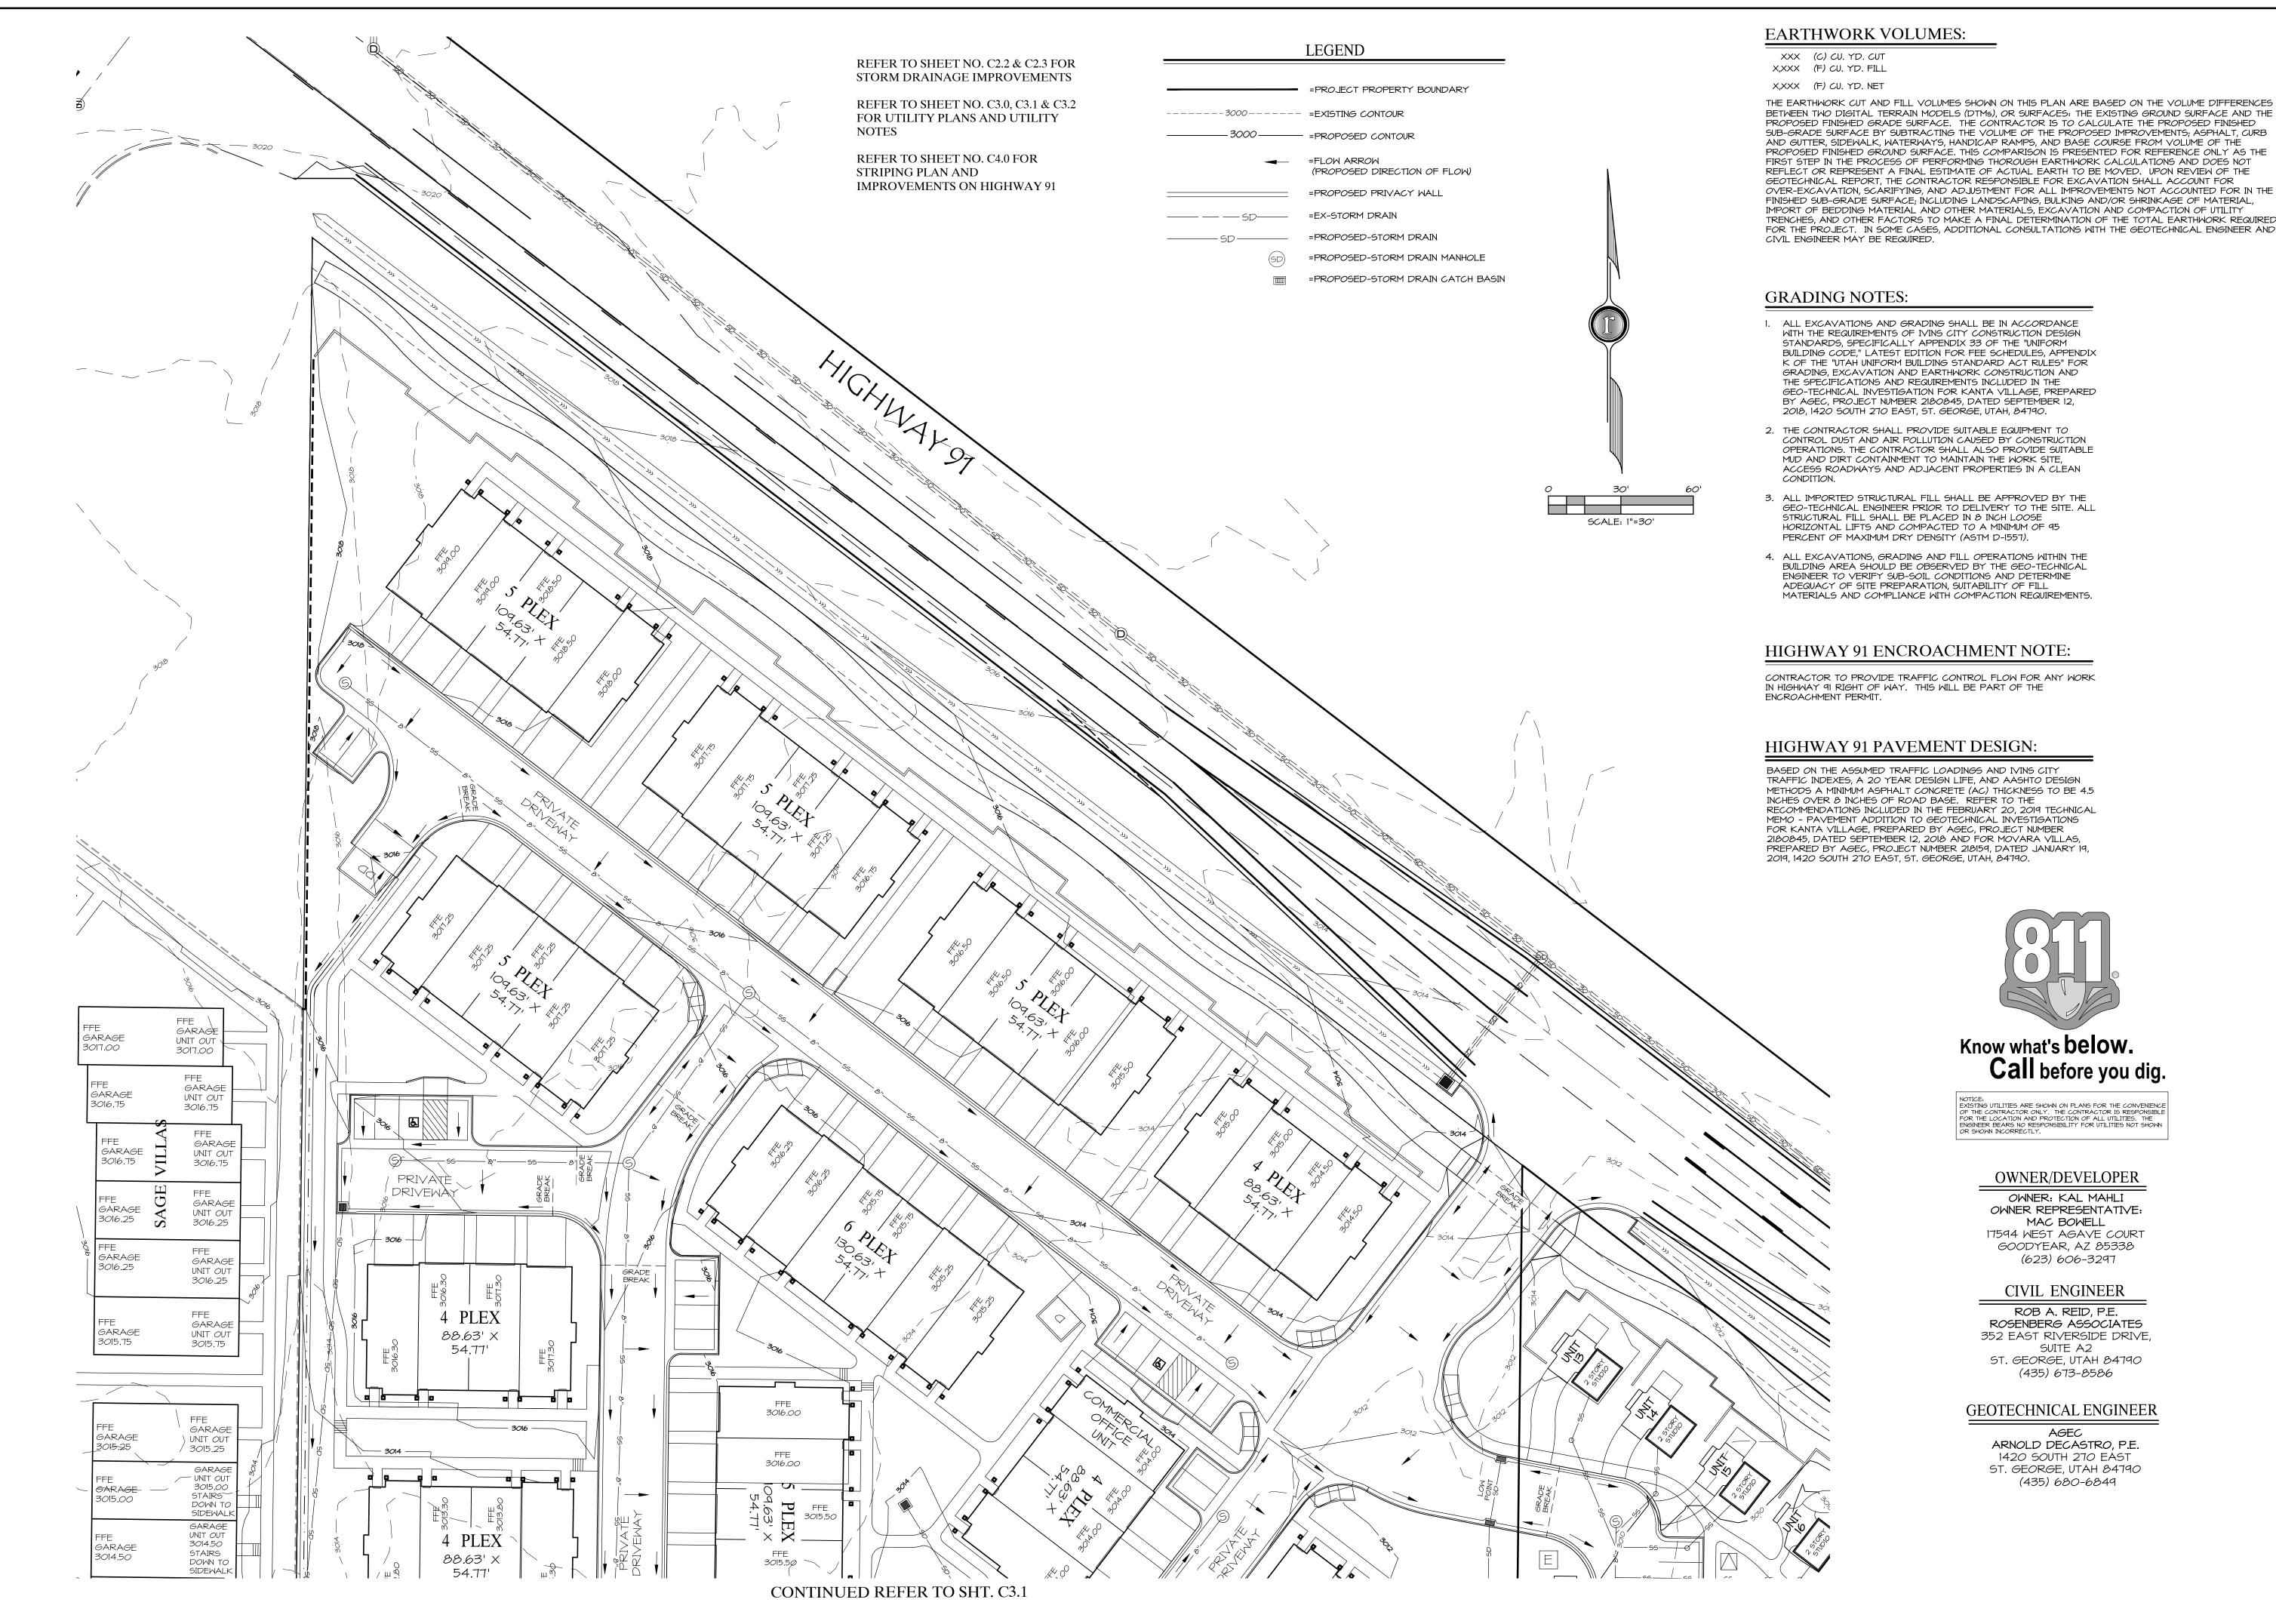
JOB NO.: 5881-18-018 **DESIGNED BY:** CHECKED BY: RAR DWG: BM 5881 Master
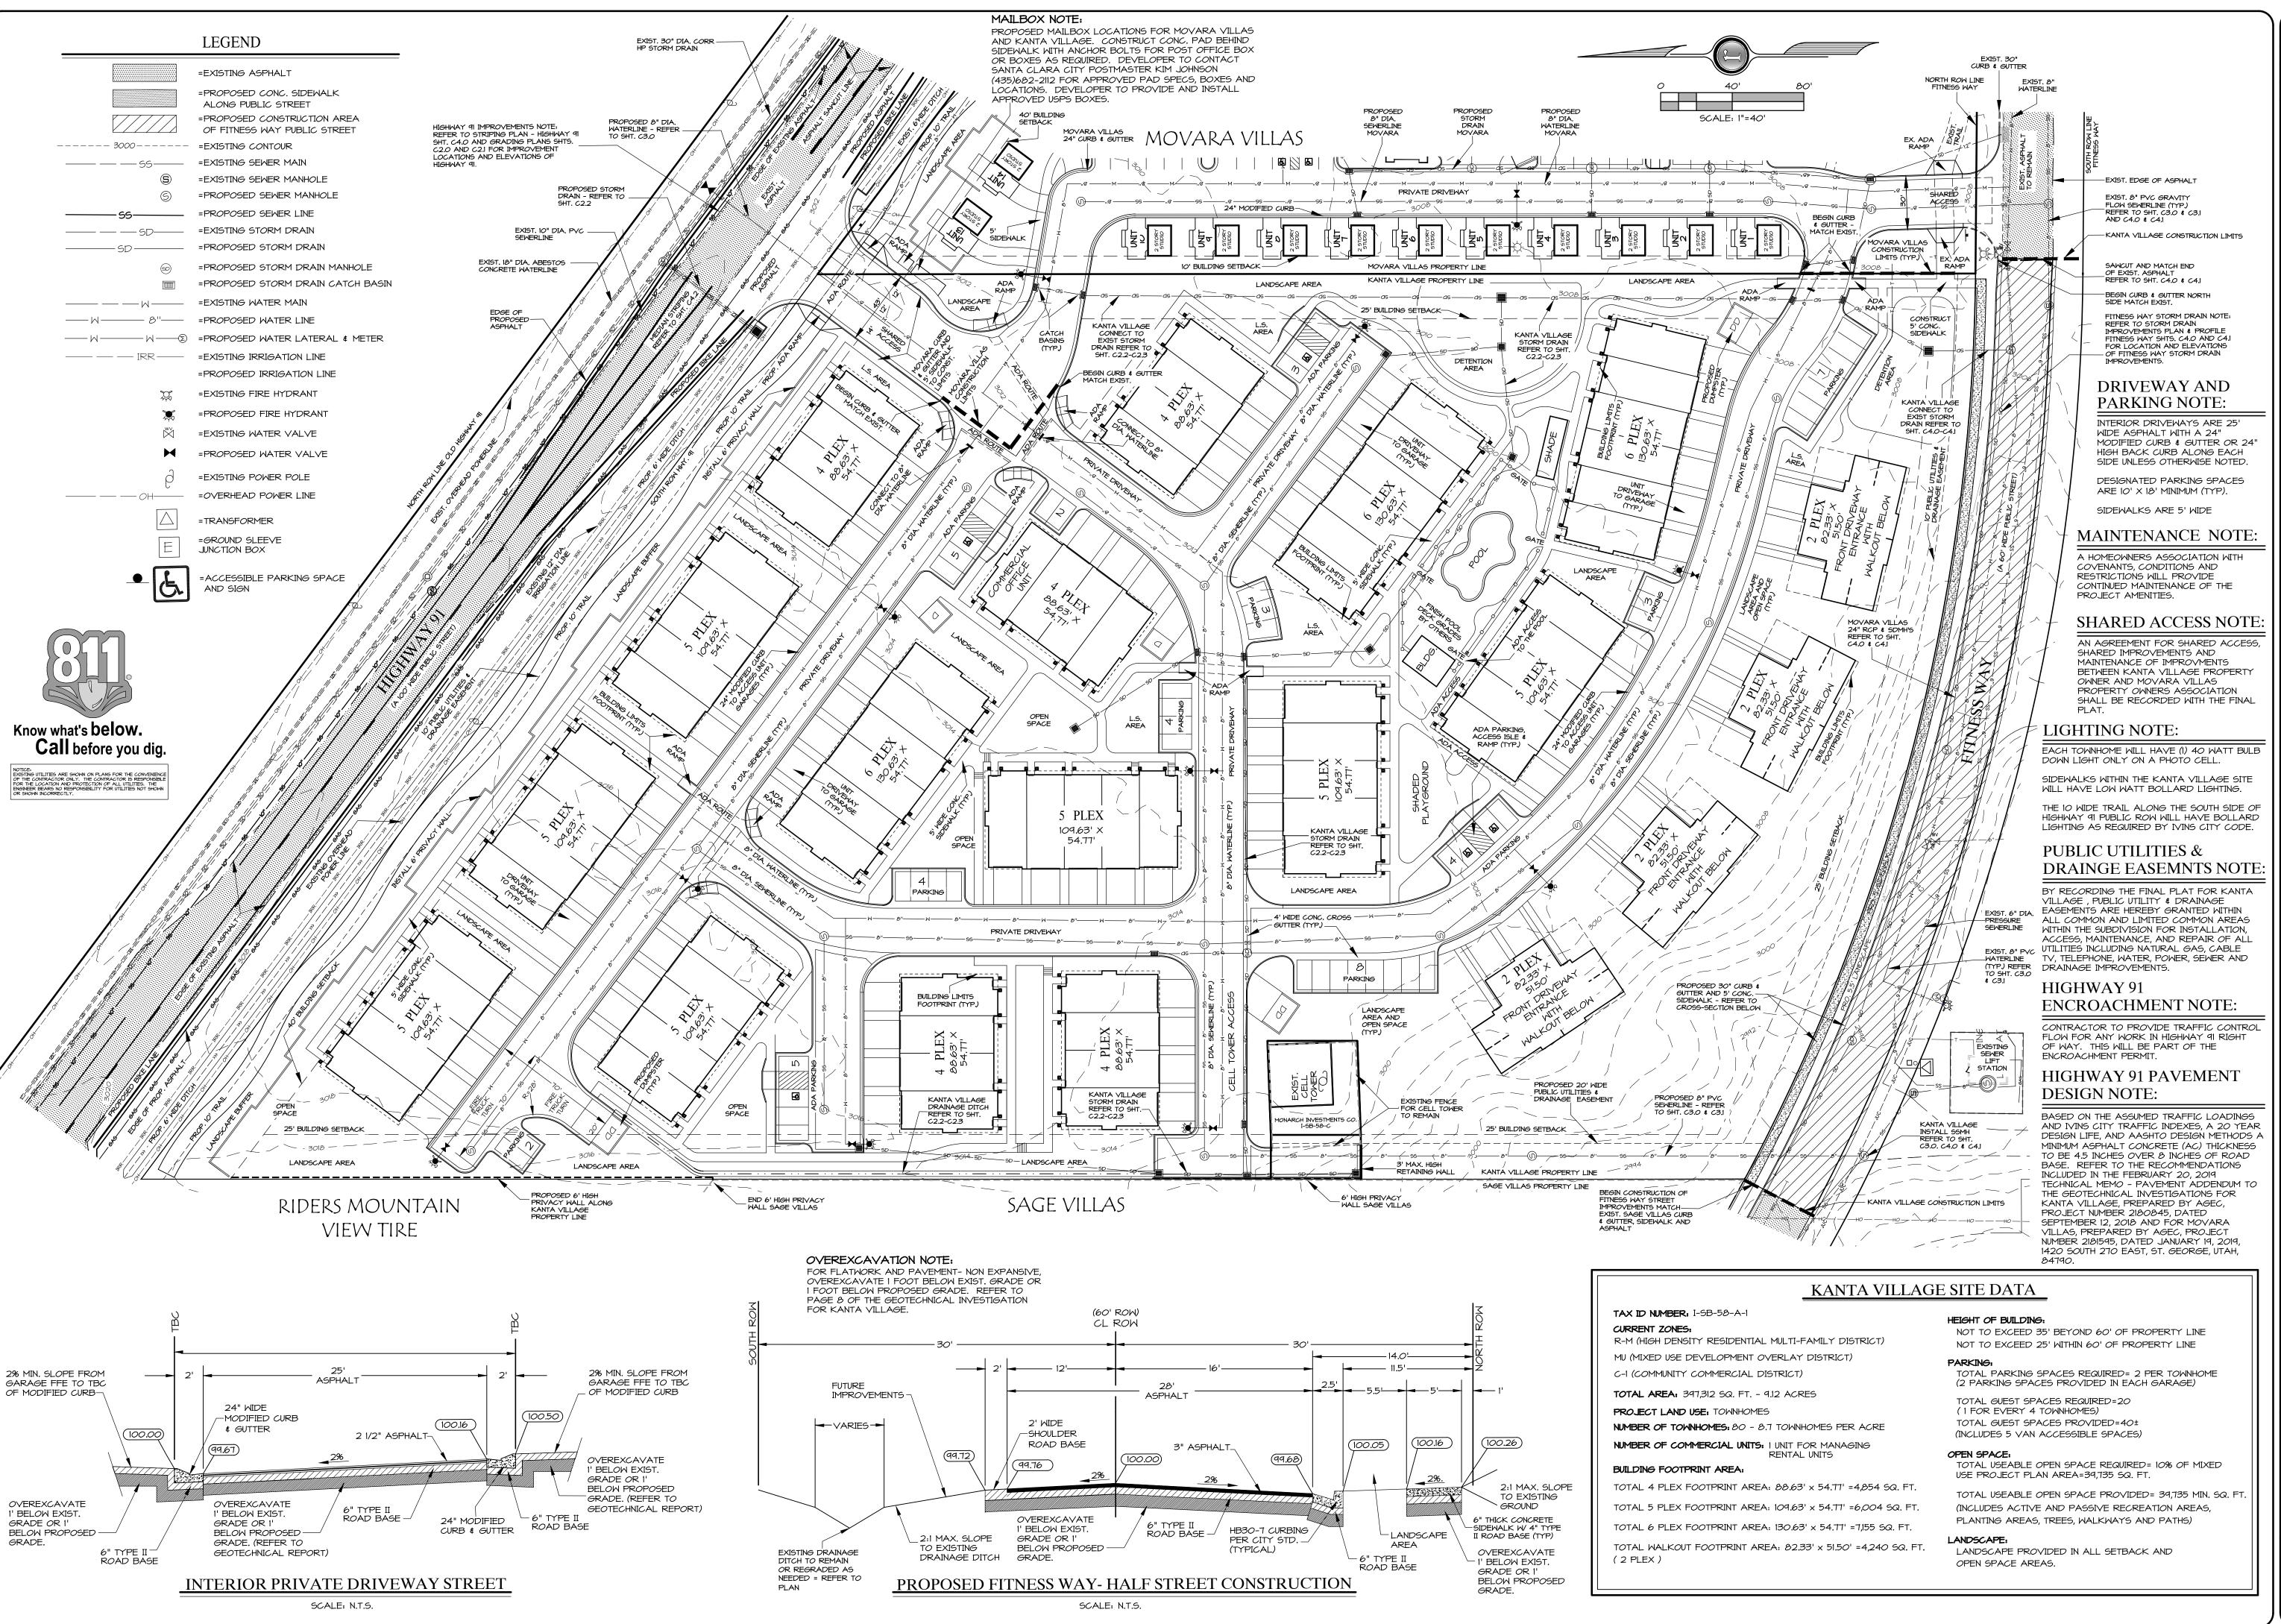
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NOT FOR CONSTRUCTION PLANS NOT APPROVED

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EARTHWORK VOLUMES:

BETWEEN TWO DIGITAL TERRAIN MODELS (DTMs), OR SURFACES: THE EXISTING GROUND SURFACE AND THE PROPOSED FINISHED GRADE SURFACE. THE CONTRACTOR IS TO CALCULATE THE PROPOSED FINISHED SUB-GRADE SURFACE BY SUBTRACTING THE VOLUME OF THE PROPOSED IMPROVEMENTS; ASPHALT, CURB AND GUTTER, SIDEWALK, WATERWAYS, HANDICAP RAMPS, AND BASE COURSE FROM VOLUME OF THE PROPOSED FINISHED GROUND SURFACE. THIS COMPARISON IS PRESENTED FOR REFERENCE ONLY AS THE FIRST STEP IN THE PROCESS OF PERFORMING THOROUGH EARTHWORK CALCULATIONS AND DOES NOT REFLECT OR REPRESENT A FINAL ESTIMATE OF ACTUAL EARTH TO BE MOVED. UPON REVIEW OF THE GEOTECHNICAL REPORT, THE CONTRACTOR RESPONSIBLE FOR EXCAVATION SHALL ACCOUNT FOR OVER-EXCAVATION, SCARIFYING, AND ADJUSTMENT FOR ALL IMPROVEMENTS NOT ACCOUNTED FOR IN THE

FINISHED SUB-GRADE SURFACE; INCLUDING LANDSCAPING, BULKING AND/OR SHRINKAGE OF MATERIAL, IMPORT OF BEDDING MATERIAL AND OTHER MATERIALS, EXCAVATION AND COMPACTION OF UTILITY TRENCHES, AND OTHER FACTORS TO MAKE A FINAL DETERMINATION OF THE TOTAL EARTHWORK REQUIRED FOR THE PROJECT. IN SOME CASES, ADDITIONAL CONSULTATIONS WITH THE GEOTECHNICAL ENGINEER AND CIVIL ENGINEER MAY BE REQUIRED.

- 1. ALL EXCAVATIONS AND GRADING SHALL BE IN ACCORDANCE WITH THE REQUIREMENTS OF IVINS CITY CONSTRUCTION DESIGN STANDARDS, SPECIFICALLY APPENDIX 33 OF THE "UNIFORM BUILDING CODE," LATEST EDITION FOR FEE SCHEDULES, APPENDIX K OF THE "UTAH UNIFORM BUILDING STANDARD ACT RULES" FOR GRADING, EXCAVATION AND EARTHWORK CONSTRUCTION AND THE SPECIFICATIONS AND REQUIREMENTS INCLUDED IN THE GEO-TECHNICAL INVESTIGATION FOR KANTA VILLAGE, PREPARED BY AGEC, PROJECT NUMBER 2180845, DATED SEPTEMBER 12, 2018, 1420 SOUTH 270 EAST, ST. GEORGE, UTAH, 84790.
- 2. THE CONTRACTOR SHALL PROVIDE SUITABLE EQUIPMENT TO CONTROL DUST AND AIR POLLUTION CAUSED BY CONSTRUCTION OPERATIONS. THE CONTRACTOR SHALL ALSO PROVIDE SUITABLE MUD AND DIRT CONTAINMENT TO MAINTAIN THE WORK SITE, ACCESS ROADWAYS AND ADJACENT PROPERTIES IN A CLEAN
- 3. ALL IMPORTED STRUCTURAL FILL SHALL BE APPROVED BY THE GEO-TECHNICAL ENGINEER PRIOR TO DELIVERY TO THE SITE. ALL STRUCTURAL FILL SHALL BE PLACED IN 8 INCH LOOSE HORIZONTAL LIFTS AND COMPACTED TO A MINIMUM OF 95 PERCENT OF MAXIMUM DRY DENSITY (ASTM D-1557).
- 4. ALL EXCAVATIONS, GRADING AND FILL OPERATIONS WITHIN THE BUILDING AREA SHOULD BE OBSERVED BY THE GEO-TECHNICAL ENGINEER TO VERIFY SUB-SOIL CONDITIONS AND DETERMINE ADEQUACY OF SITE PREPARATION, SUITABILITY OF FILL MATERIALS AND COMPLIANCE WITH COMPACTION REQUIREMENTS.

HIGHWAY 91 ENCROACHMENT NOTE:

CONTRACTOR TO PROVIDE TRAFFIC CONTROL FLOW FOR ANY WORK IN HIGHWAY 91 RIGHT OF WAY. THIS WILL BE PART OF THE

HIGHWAY 91 PAVEMENT DESIGN:

TRAFFIC INDEXES, A 20 YEAR DESIGN LIFE, AND AASHTO DESIGN METHODS A MINIMUM ASPHALT CONCRETE (AC) THICKNESS TO BE 4.5 INCHES OVER 8 INCHES OF ROAD BASE. REFER TO THE RECOMMENDATIONS INCLUDED IN THE FEBRUARY 20, 2019 TECHNICAL MEMO - PAVEMENT ADDITION TO GEOTECHNICAL INVESTIGATIONS FOR KANTA VILLAGE, PREPARED BY AGEC, PROJECT NUMBER 2180845, DATED SEPTEMBER 12, 2018 AND FOR MOVARA VILLAS, PREPARED BY AGEC, PROJECT NUMBER 218159, DATED JANUARY 19, 2019, 1420 SOUTH 270 EAST, ST. GEORGE, UTAH, 84790.



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NOTICE:
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OF THE CONTRACTOR ONLY. THE CONTRACTOR IS RESPONSIBLE
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OR SHOWN INCORRECTLY.

OWNER/DEVELOPER OWNER: KAL MAHLI

OWNER REPRESENTATIVE: MAC BOWELL 17594 WEST AGAVE COURT 600DYEAR, AZ 85338 (623) 606-3297

CIVIL ENGINEER

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GEOTECHNICAL ENGINEER


AGEC ARNOLD DECASTRO, P.E. 1420 SOUTH 270 EAST ST. GEORGE, UTAH 84790 (435) 680-6849

10156-17 **DESIGNED BY:** LMM CHECKED BY: RAR DWG: BMap 5881 Master



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LEGEND

- = PROJECT PROPERTY BOUNDARY

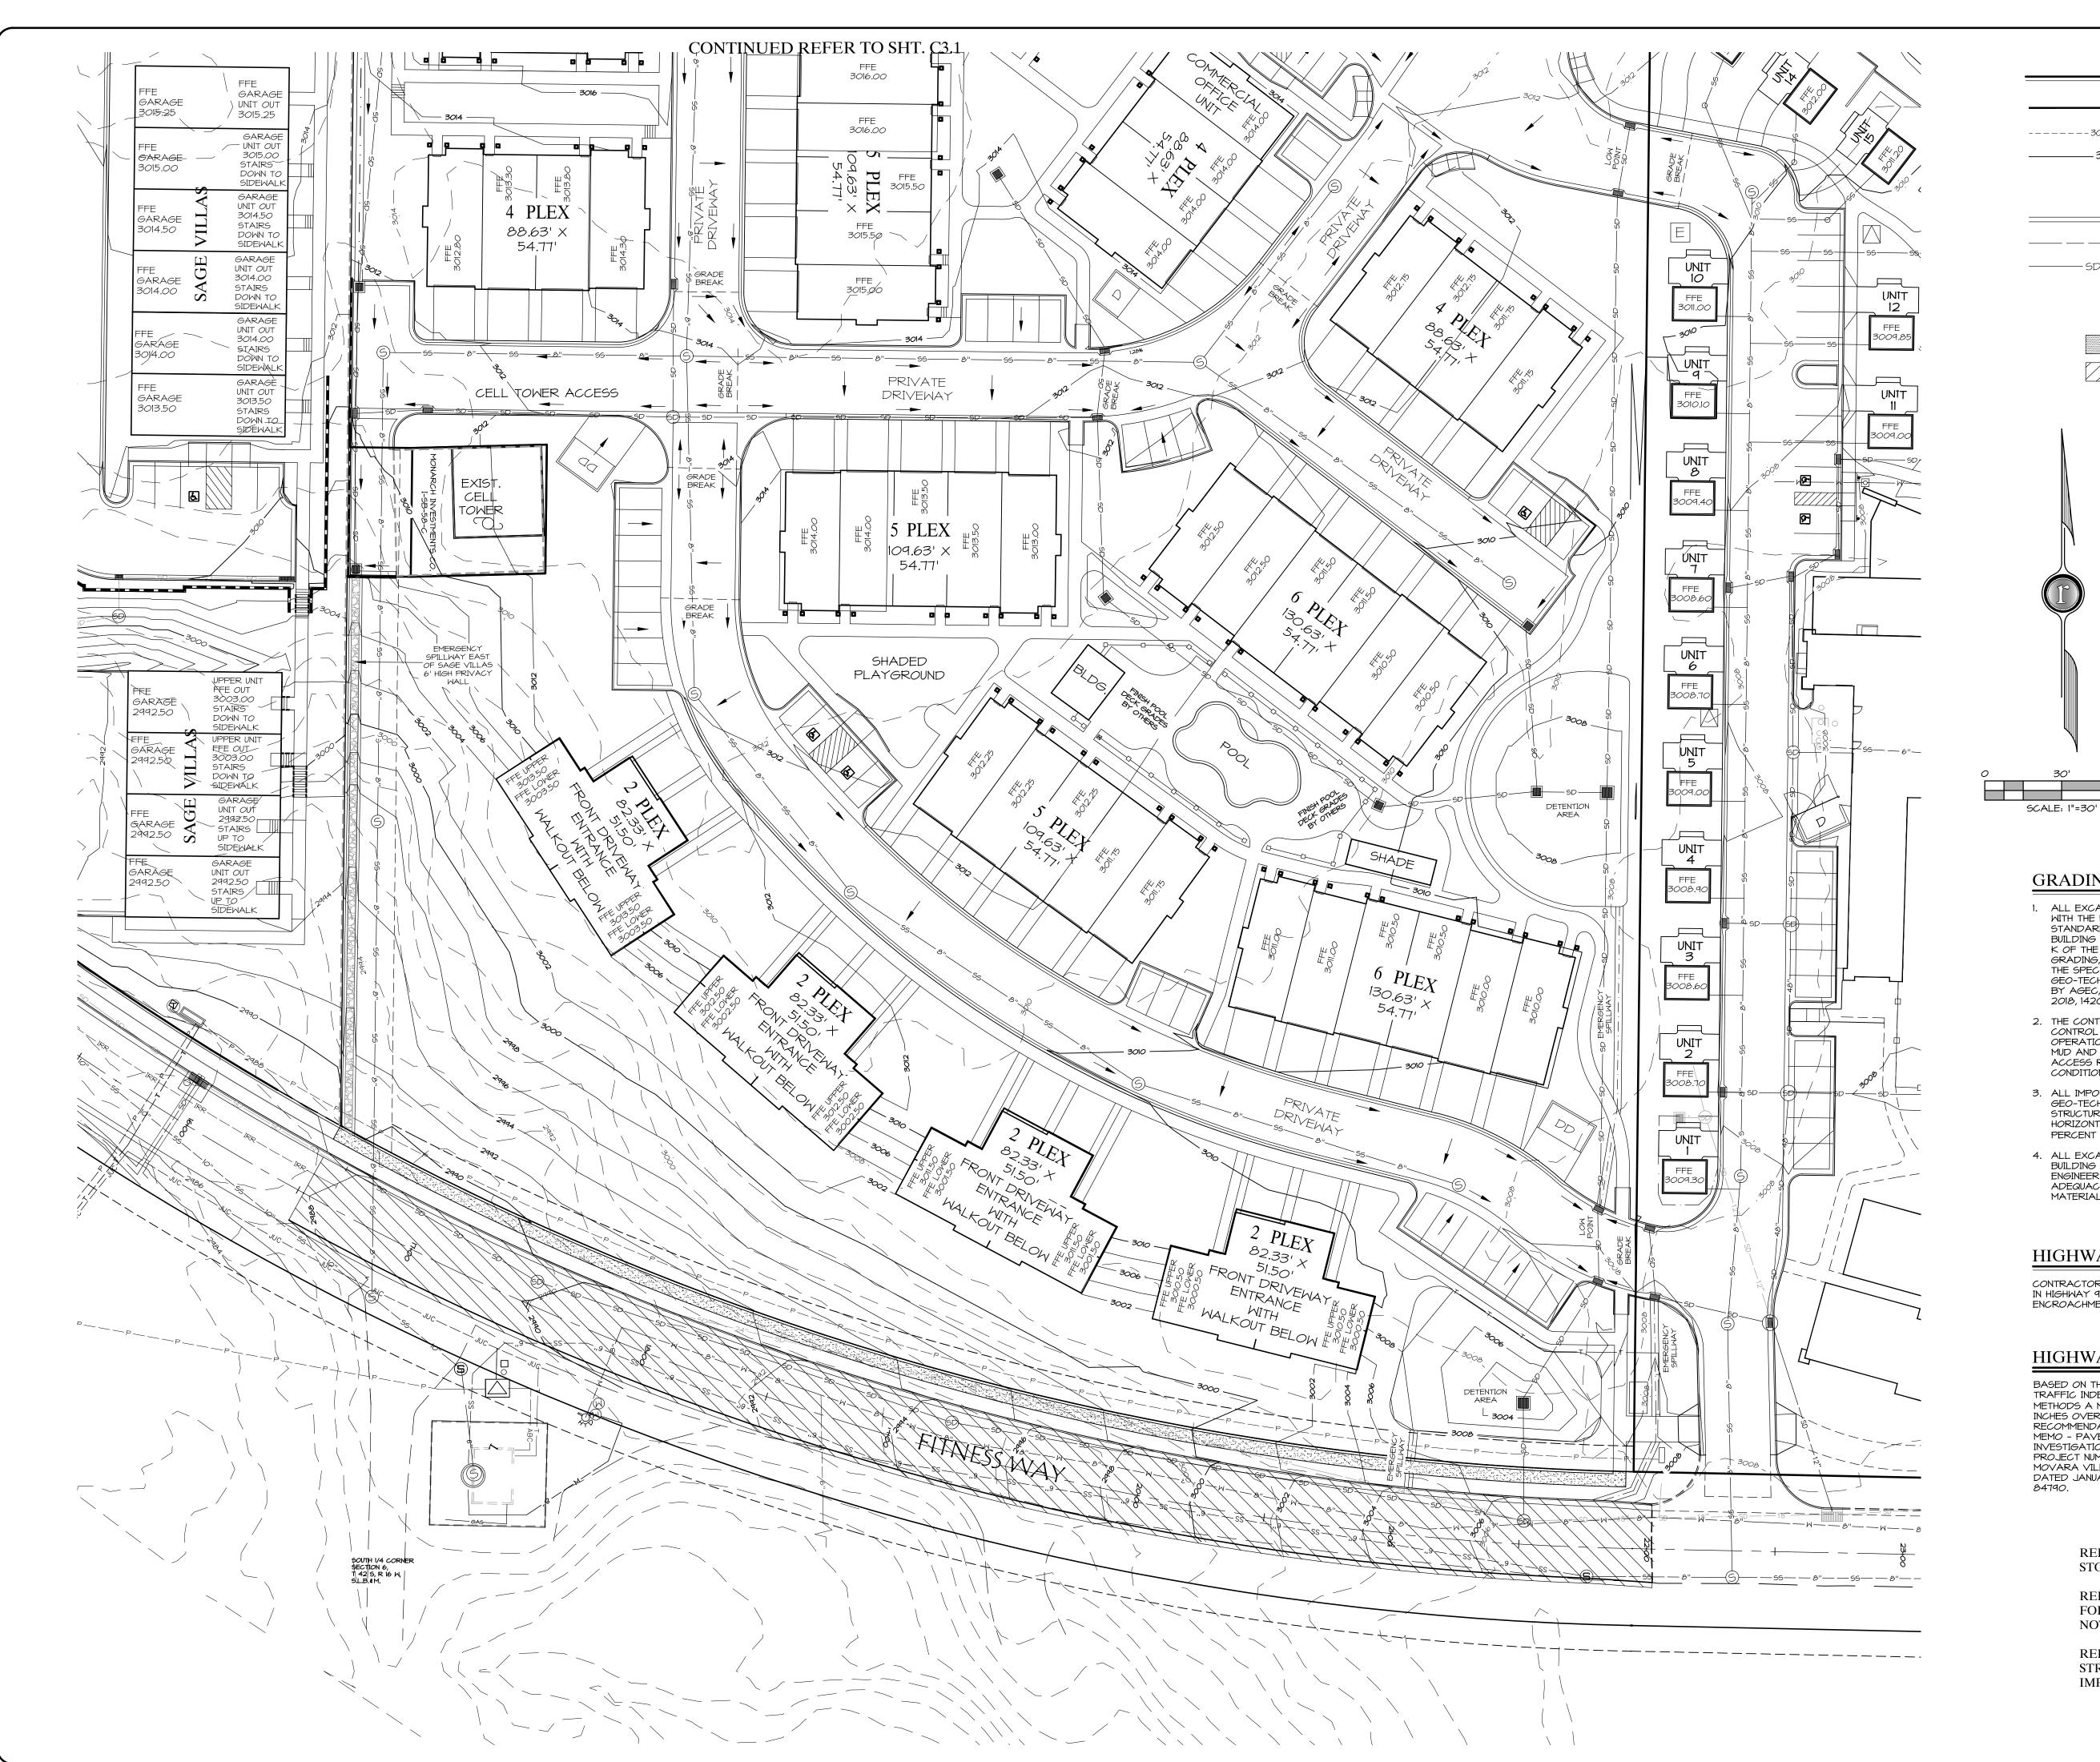----- =EXISTING CONTOUR

----- 3000 ----- = PROPOSED CONTOUR


=FLOW ARROW (PROPOSED DIRECTION OF FLOW)

=PROPOSED PRIVACY WALL =EX-STORM DRAIN


=PROPOSED-STORM DRAIN

=PROPOSED-STORM DRAIN MANHOLE

=PROPOSED-STORM DRAIN CATCH BASIN

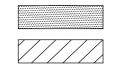

=PROPOSED CONC. SIDEWALK ALONG PUBLIC STREET =PROPOSED CONSTRUCTION AREA OF FITNESS WAY PUBLIC STREET

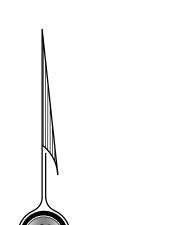

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HIGHWAY 91 ENCROACHMENT NOTE:

CONTRACTOR TO PROVIDE TRAFFIC CONTROL FLOW FOR ANY WORK IN HIGHWAY 91 RIGHT OF WAY. THIS WILL BE PART OF THE ENCROACHMENT PERMIT.

HIGHWAY 91 PAVEMENT DESIGN:

BASED ON THE ASSUMED TRAFFIC LOADINGS AND IVINS CITY TRAFFIC INDEXES, A 20 YEAR DESIGN LIFE, AND AASHTO DESIGN METHODS A MINIMUM ASPHALT CONCRETE (AC) THICKNESS TO BE 4.5 INCHES OVER & INCHES OF ROAD BASE. REFER TO THE RECOMMENDATIONS INCLUDED IN THE FEBRUARY 20, 2019 TECHNICAL MEMO - PAVEMENT ADDENDUM TO THE GEOTECHNICAL INVESTIGATIONS FOR KANTA VILLAGE, PREPARED BY AGEC, PROJECT NUMBER 2180845, DATED SEPTEMBER 12, 2018 AND FOR MOVARA VILLAS, PREPARED BY AGEC, PROJECT NUMBER 2181595, DATED JANUARY 19, 2019, 1420 SOUTH 270 EAST, ST. GEORGE, UTAH,

> REFER TO SHEET NO. C2.2 & C2.3 FOR STORM DRAINAGE IMPROVEMENTS


> REFER TO SHEET NO. C3.0, C3.1 & C3.2 FOR UTILITY PLANS AND UTILITY NOTES

REFER TO SHEET NO. C4.0 FOR STRIPING PLAN AND **IMPROVEMENTS ON HIGHWAY 91** JOB NO.: 10156-17 **DESIGNED BY:** LMM CHECKED BY: DWG: BMap 5881 Master



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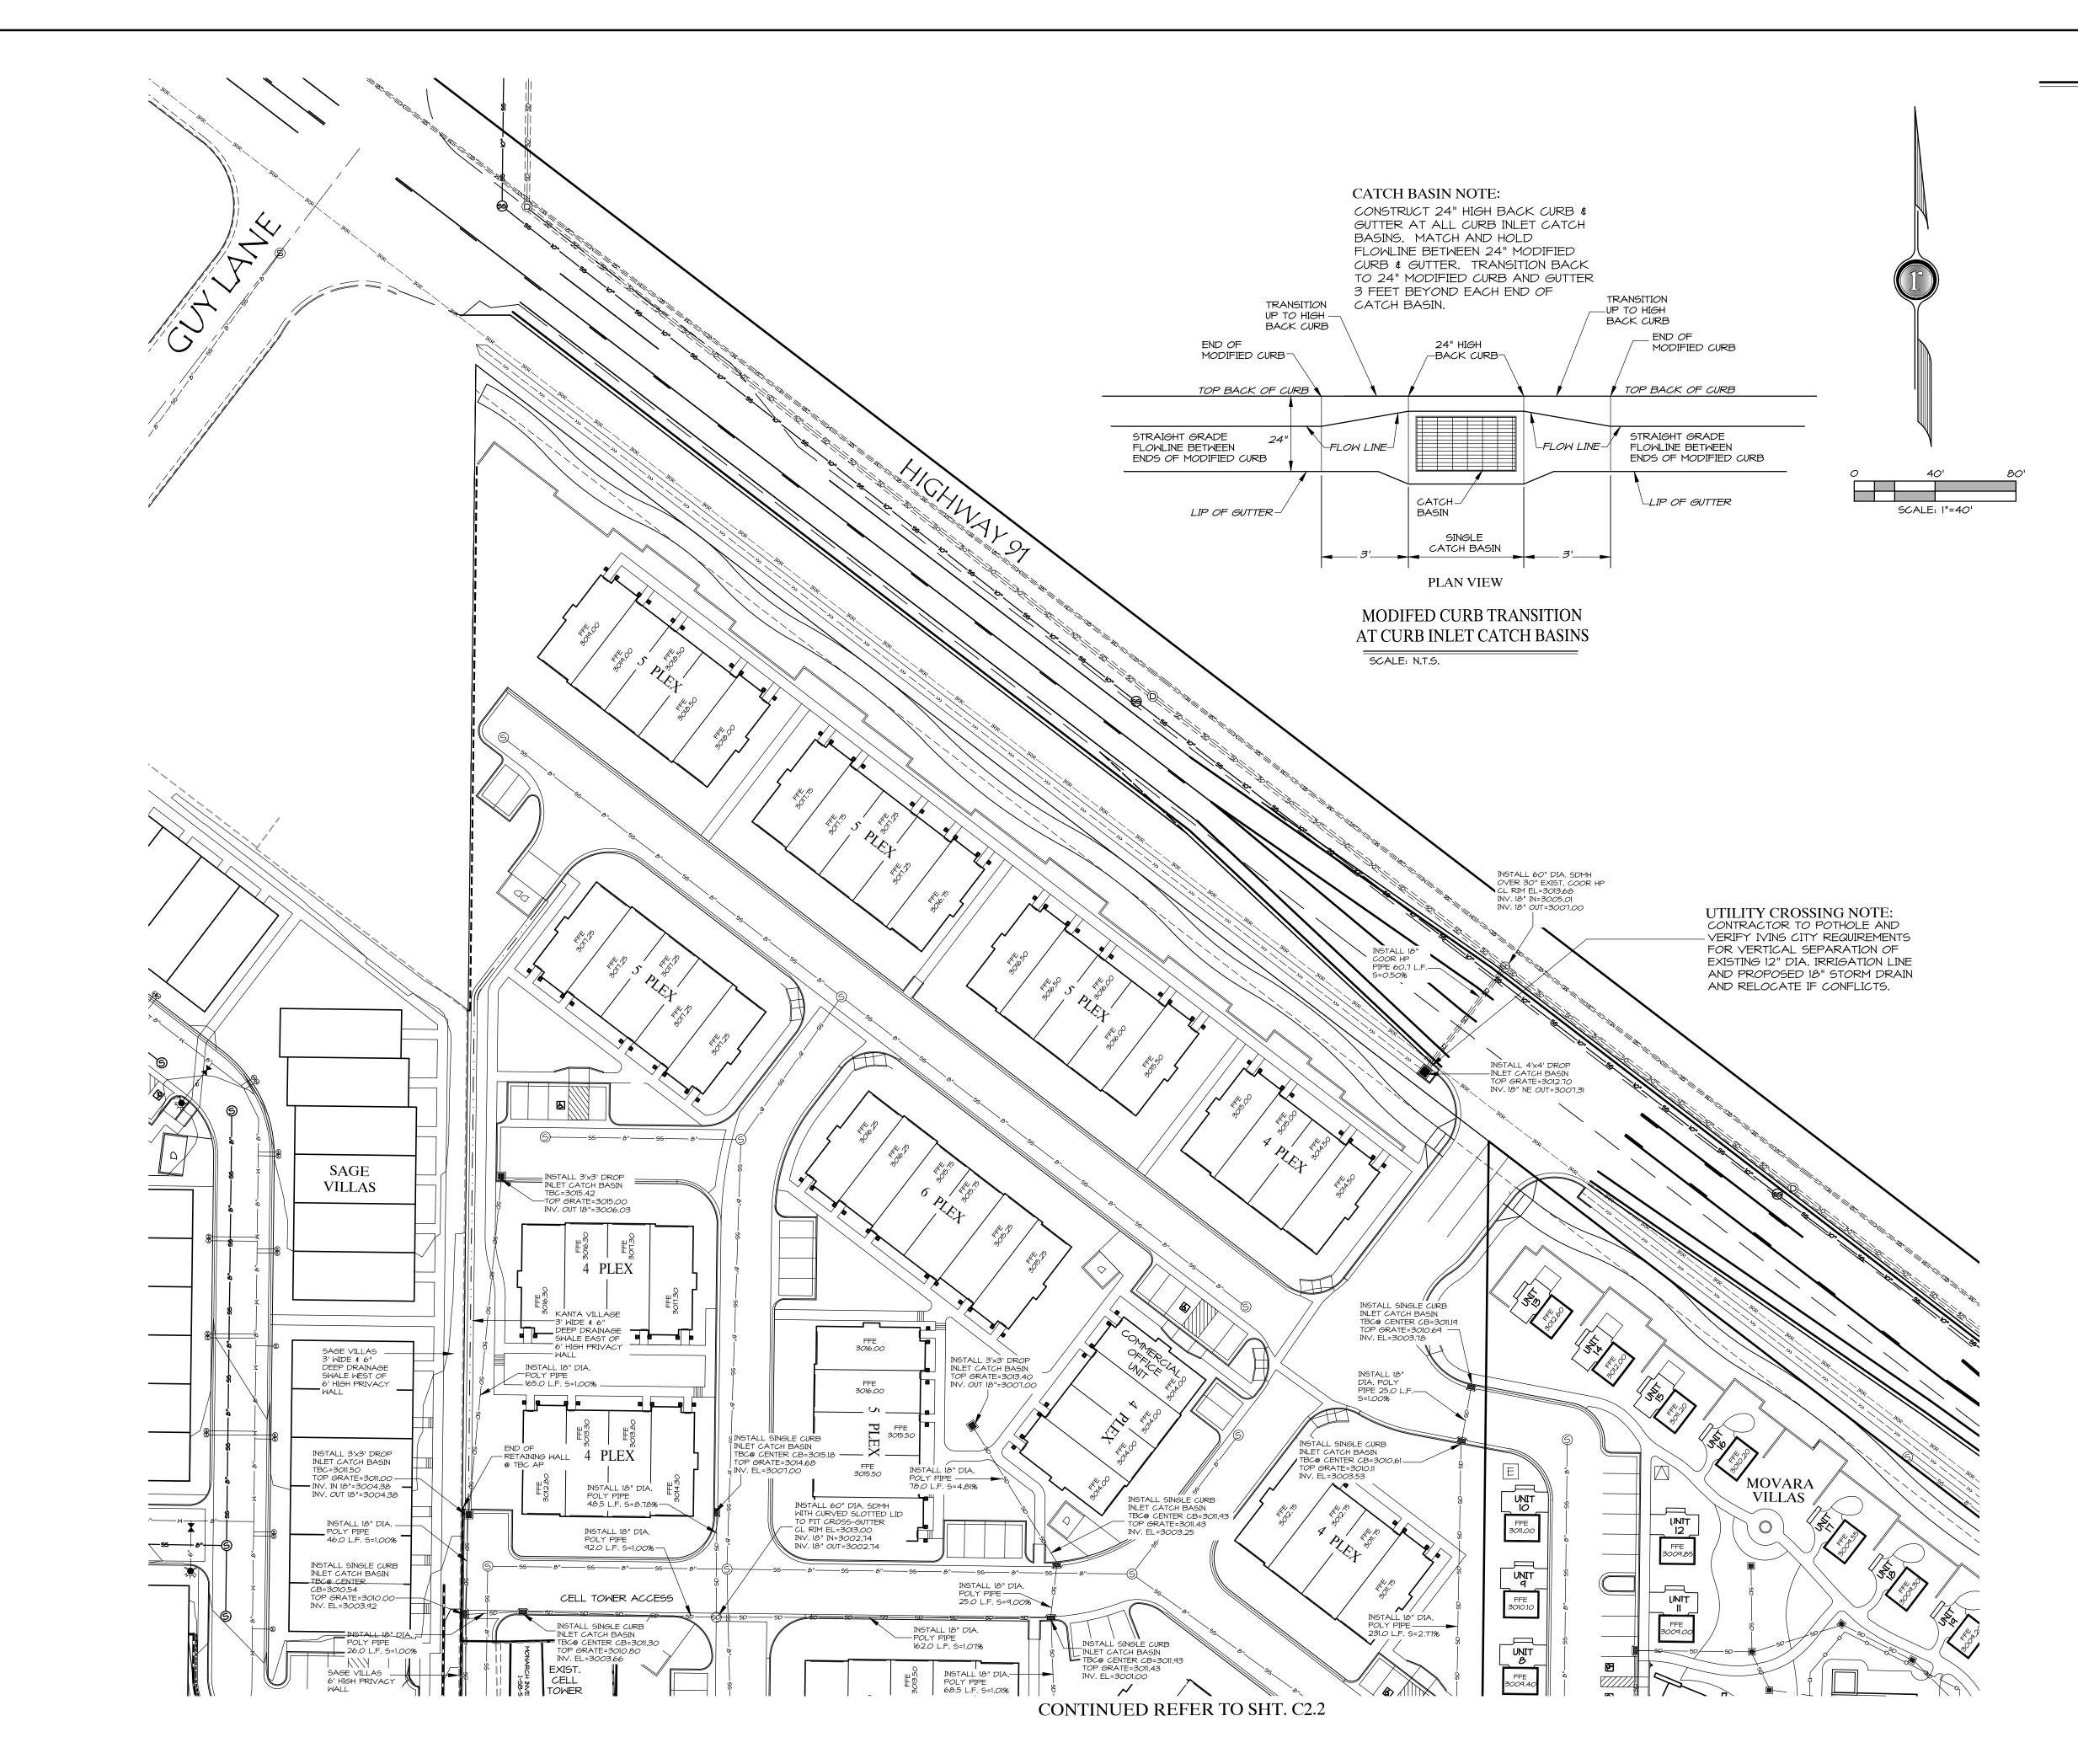
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5881-18-017 DWG: BM 5881 Master

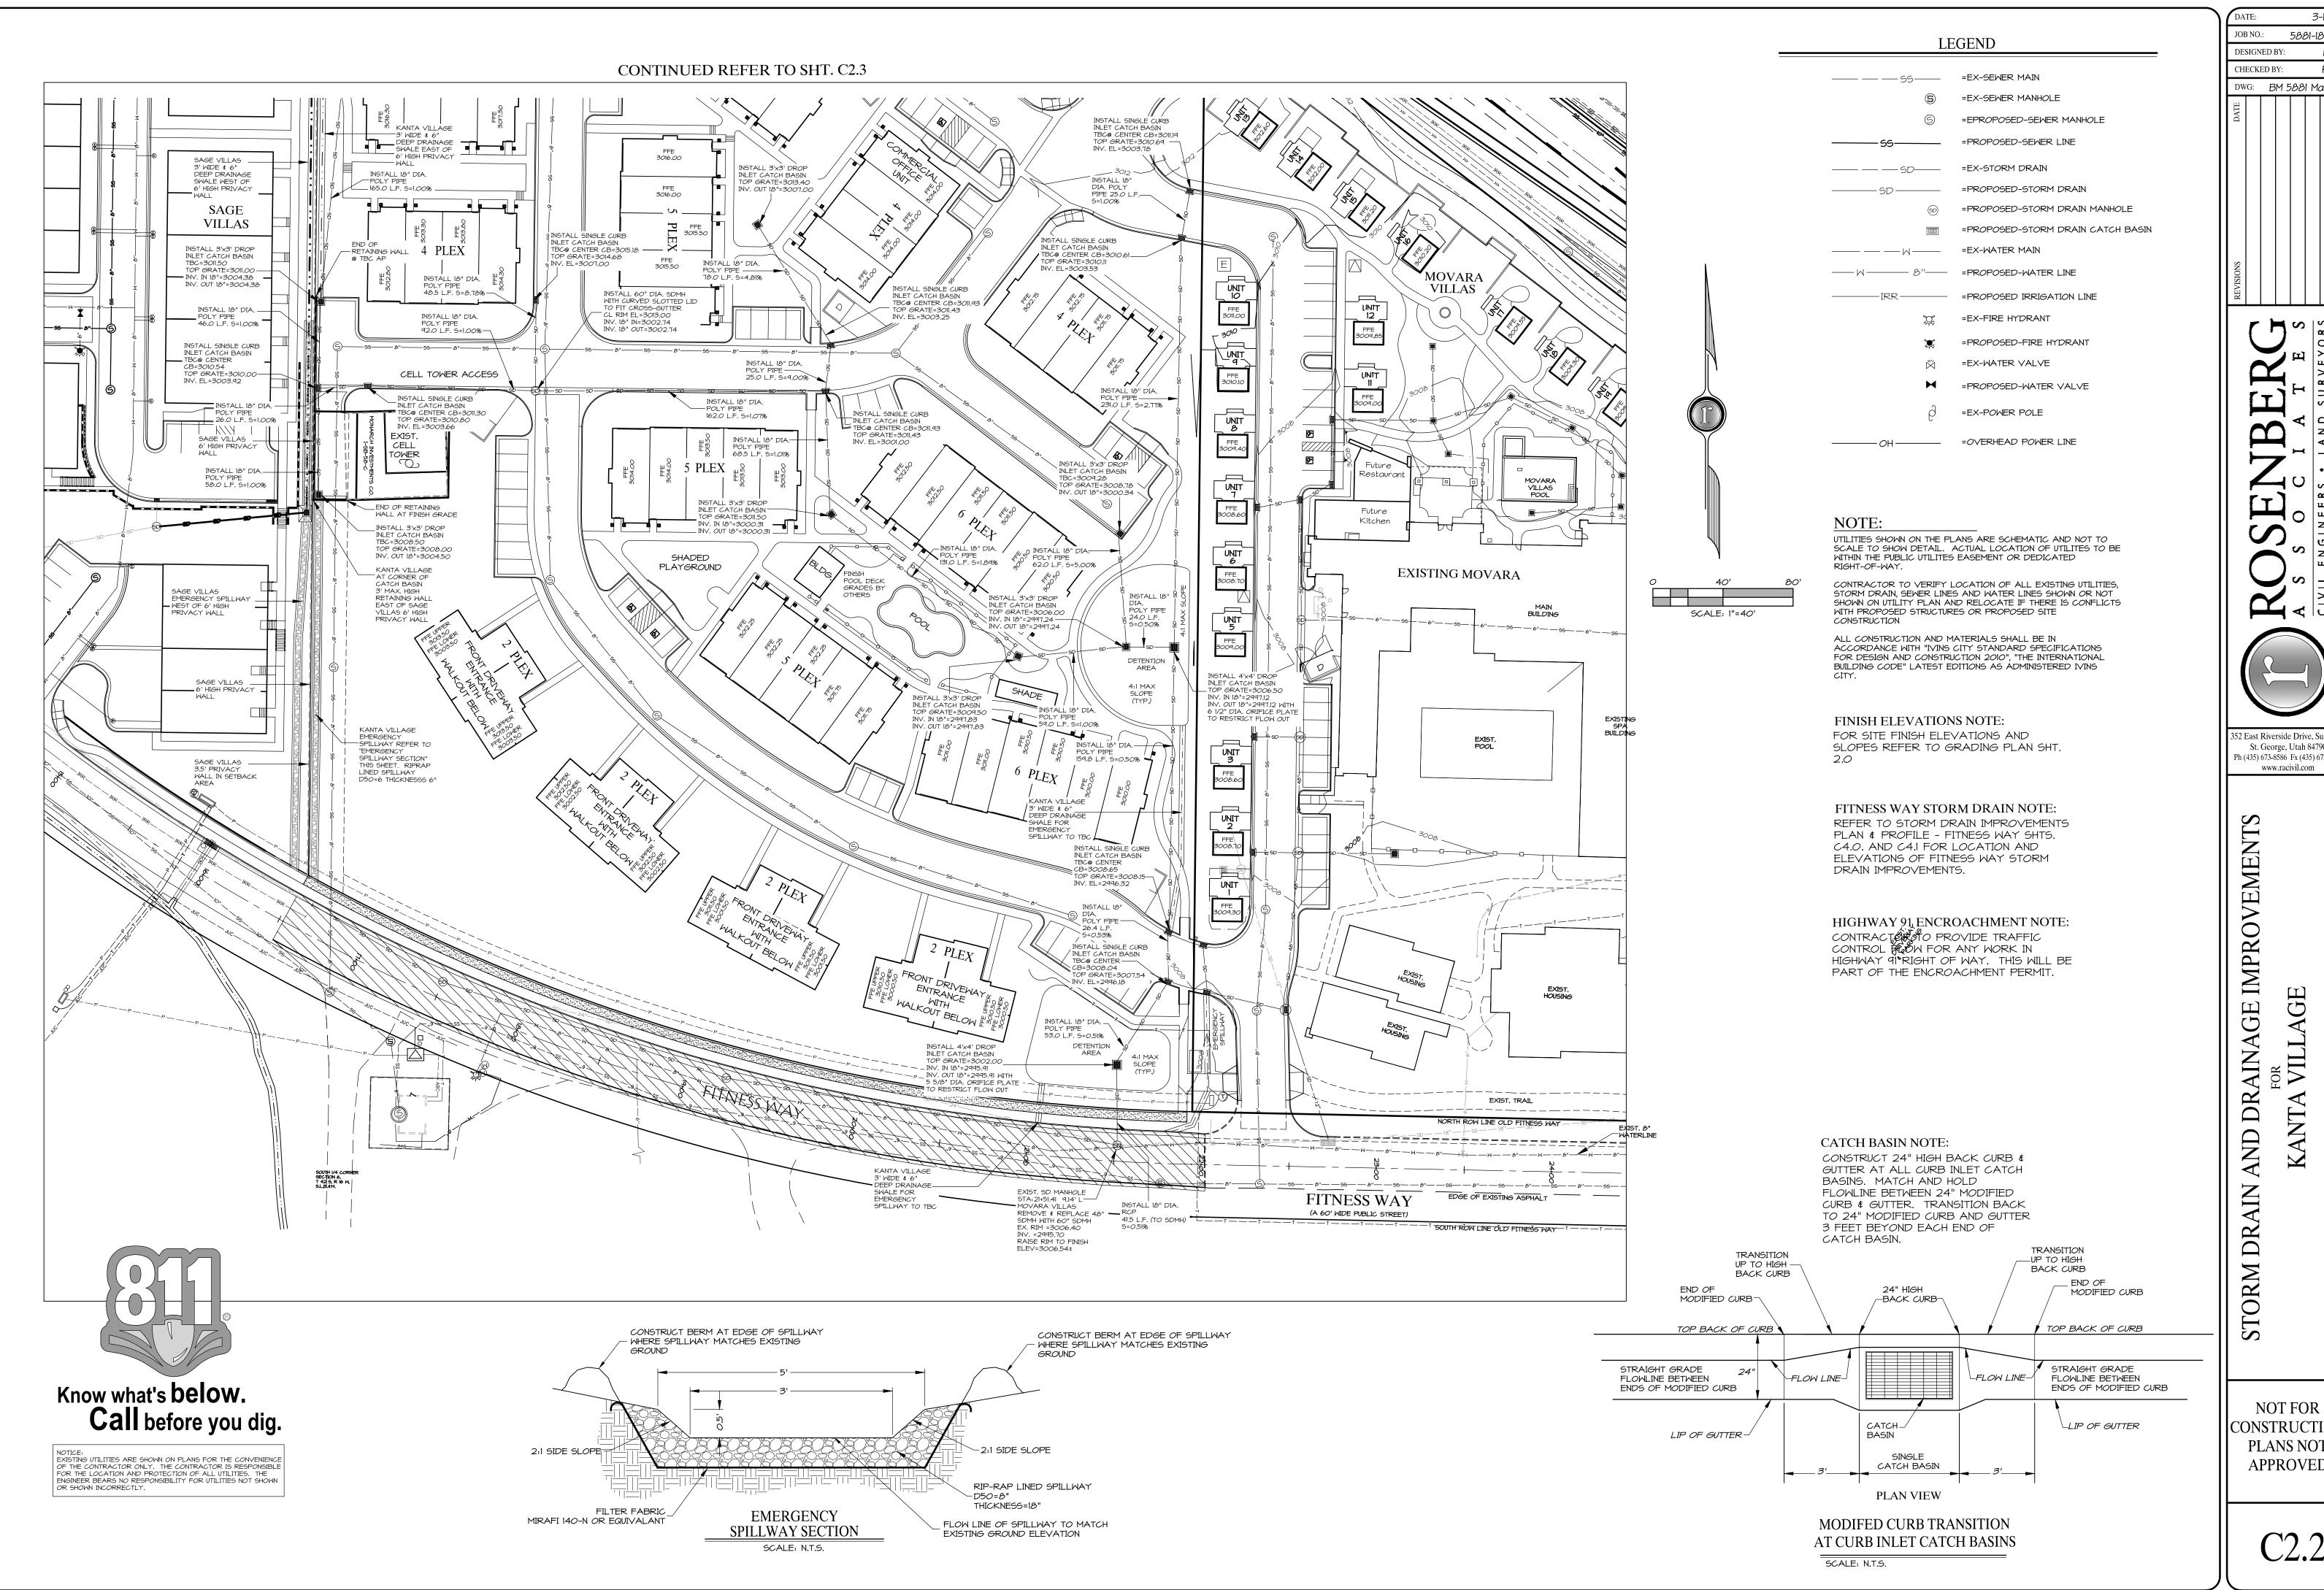

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LEGEND

	=EX-SEWER MAIN
S	=EX-SEWER MANHOLE
9	=EPROPOSED-SEWER MANHOLE
 55	=PROPOSED-SEWER LINE
	=EX-STORM DRAIN
SD	=PROPOSED-STORM DRAIN
(SD)	=PROPOSED-STORM DRAIN MANHOLE
	=PROPOSED-STORM DRAIN CATCH BASIN
	=EX-WATER MAIN
——W———— 8"——	=PROPOSED-WATER LINE
IRR	=PROPOSED IRRIGATION LINE
X	=EX-FIRE HYDRANT
×	=PROPOSED-FIRE HYDRANT
₩¥	=EX-WATER VALVE
H	=PROPOSED-WATER VALVE
Ą	=EX-POWER POLE

NOTE:

UTILITIES SHOWN ON THE PLANS ARE SCHEMATIC AND NOT TO SCALE TO SHOW DETAIL. ACTUAL LOCATION OF UTILITES TO BE WITHIN THE PUBLIC UTILITES EASEMENT OR DEDICATED RIGHT-OF-WAY.

- OH - = OVERHEAD POWER LINE

CONTRACTOR TO VERIFY LOCATION OF ALL EXISTING UTILITIES, STORM DRAIN, SEWER LINES AND WATER LINES SHOWN OR NOT SHOWN ON UTILITY PLAN AND RELOCATE IF THERE IS CONFLICTS WITH PROPOSED STRUCTURES OR PROPOSED SITE CONSTRUCTION

ALL CONSTRUCTION AND MATERIALS SHALL BE IN ACCORDANCE WITH "IVINS CITY STANDARD SPECIFICATIONS FOR DESIGN AND CONSTRUCTION 2010", "THE INTERNATIONAL BUILDING CODE" LATEST EDITIONS AS ADMINISTERED IVINS



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FINISH ELEVATIONS NOTE:
FOR SITE FINISH ELEVATIONS AND
SLOPES REFER TO GRADING PLAN SHT.

FITNESS WAY STORM DRAIN NOTE:
REFER TO STORM DRAIN IMPROVEMENTS
PLAN & PROFILE - FITNESS WAY SHTS.
C4.0. AND C4.1 FOR LOCATION AND
ELEVATIONS OF FITNESS WAY STORM
DRAIN IMPROVEMENTS.

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DATE: 3-13-19

JOB NO.: 5881-18-017

DESIGNED BY: LMM

CHECKED BY: RAR

DWG: BM 5881 Master

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S S O C I A T E S
VIL ENGINEERS - LAND SURVEYORS



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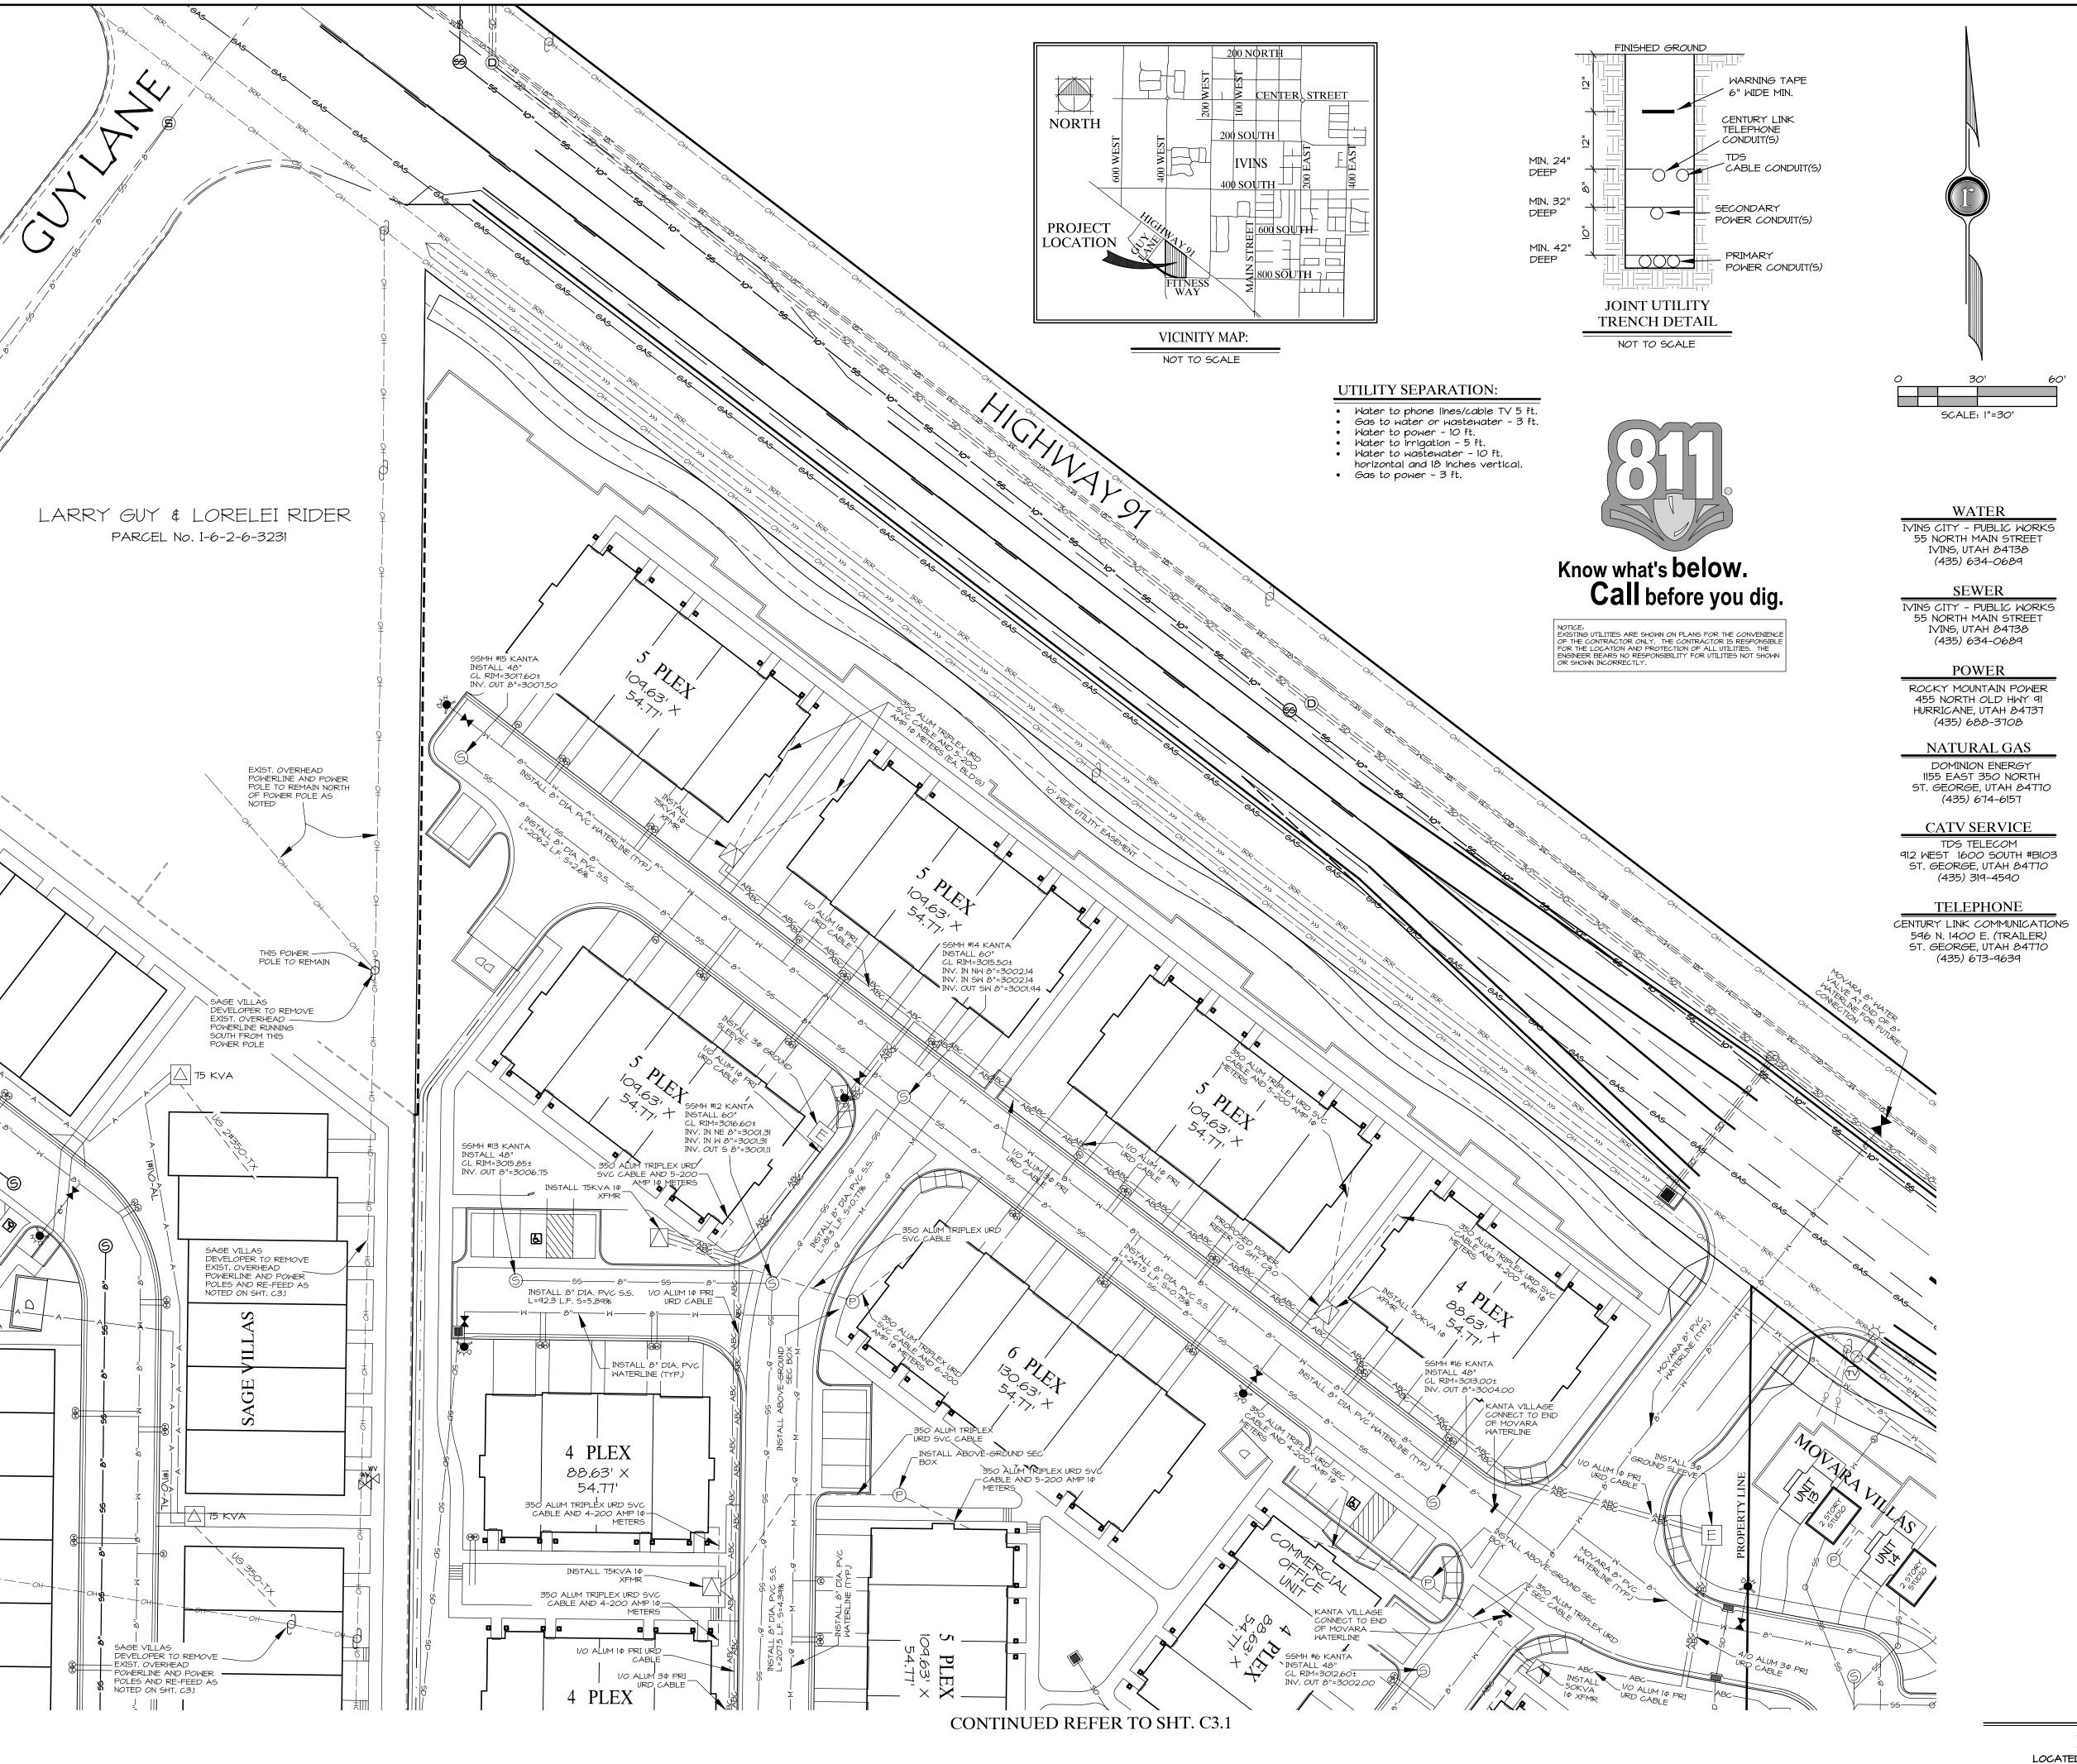
AND DRAINAGE IMPROVEME


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STORM

NOT FOR CONSTRUCTION PLANS NOT APPROVED

C2.3



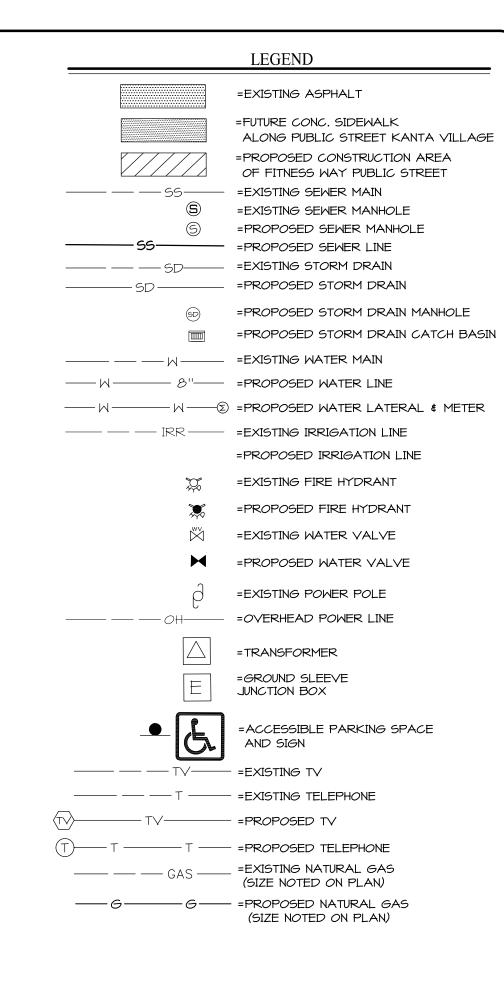

JOB NO.:

DESIGNED BY:

CHECKED BY:

DWG: BMap 5881 Master

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St. George, Utah 84790

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PUBLIC UTILITY & DRAINAGE EASEMENTS NOTE:

BY RECORDING THE FINAL PLAT FOR MOVARA VILLAS, PUBLIC UTILITY & DRAINAGE EASEMENTS ARE HEREBY GRANTED WITHIN ALL COMMON AND LIMITED COMMON AREAS WITHIN THE SUBDIVISION FOR INSTALLATION, ACCESS, MAINTENANCE, AND REPAIR OF ALL UTILITIES INCLUDING NATURAL GAS, CABLE TV, TELEPHONE, WATER, POWER, SEWER AND DRAINAGE IMPROVEMENTS.

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ROB A. REID, P.E.
ROSENBERG ASSOCIATES
352 EAST RIVERSIDE DRIVE,

SUITE A2

ST. GEORGE, UTAH 84790

(435) 673-8586

PROPERTY LOCATION

THE PROPERTY IS LOCATED WEST OF MOVARA ALONG THE SOUTH RIGHT-OF-WAY LINE OF HIGHWAY 91 AND ALONG THE NORTH RIGHT-OF-WAY LINE OF FITNESS WAY IVINS, UTAH

PROPERTY ADDRESS

KANTA VILLAGE
343 WEST HIGHWAY 9I
IVINS, UT 84738

PARCEL ACREAGE

397,312 SQ. FT. - 9.12 ACRES

GEOTECHNICAL
ENGINEER

AGEC
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1420 SOUTH 270 EAST ST. GEORGE, UTAH 84790 (435) 680-6849

OWNER/DEVELOPER

OWNER: KAL MALHI
OWNER REPRESENTATIVE:
MAC BOWELL

MAC BOWELL
17594 WEST AGAVE COURT
GOODYEAR, AZ 85338
(623) 606-3297

KANTA VILLAGE


POWER, SEWER AND WATER PLAN


LOCATED IN SOUTH 1/4 OF SECTION 6, TOWNSHIP 42 SOUTH, RANGE 16 WEST
OF THE SALT LAKE BASE AND MERIDIAN IN THE CITY OF IVINS, WASHINGTON COUNTY, UTAH.

CONSTRUCTION
PLANS NOT
APPROVED

NOT FOR

3.0

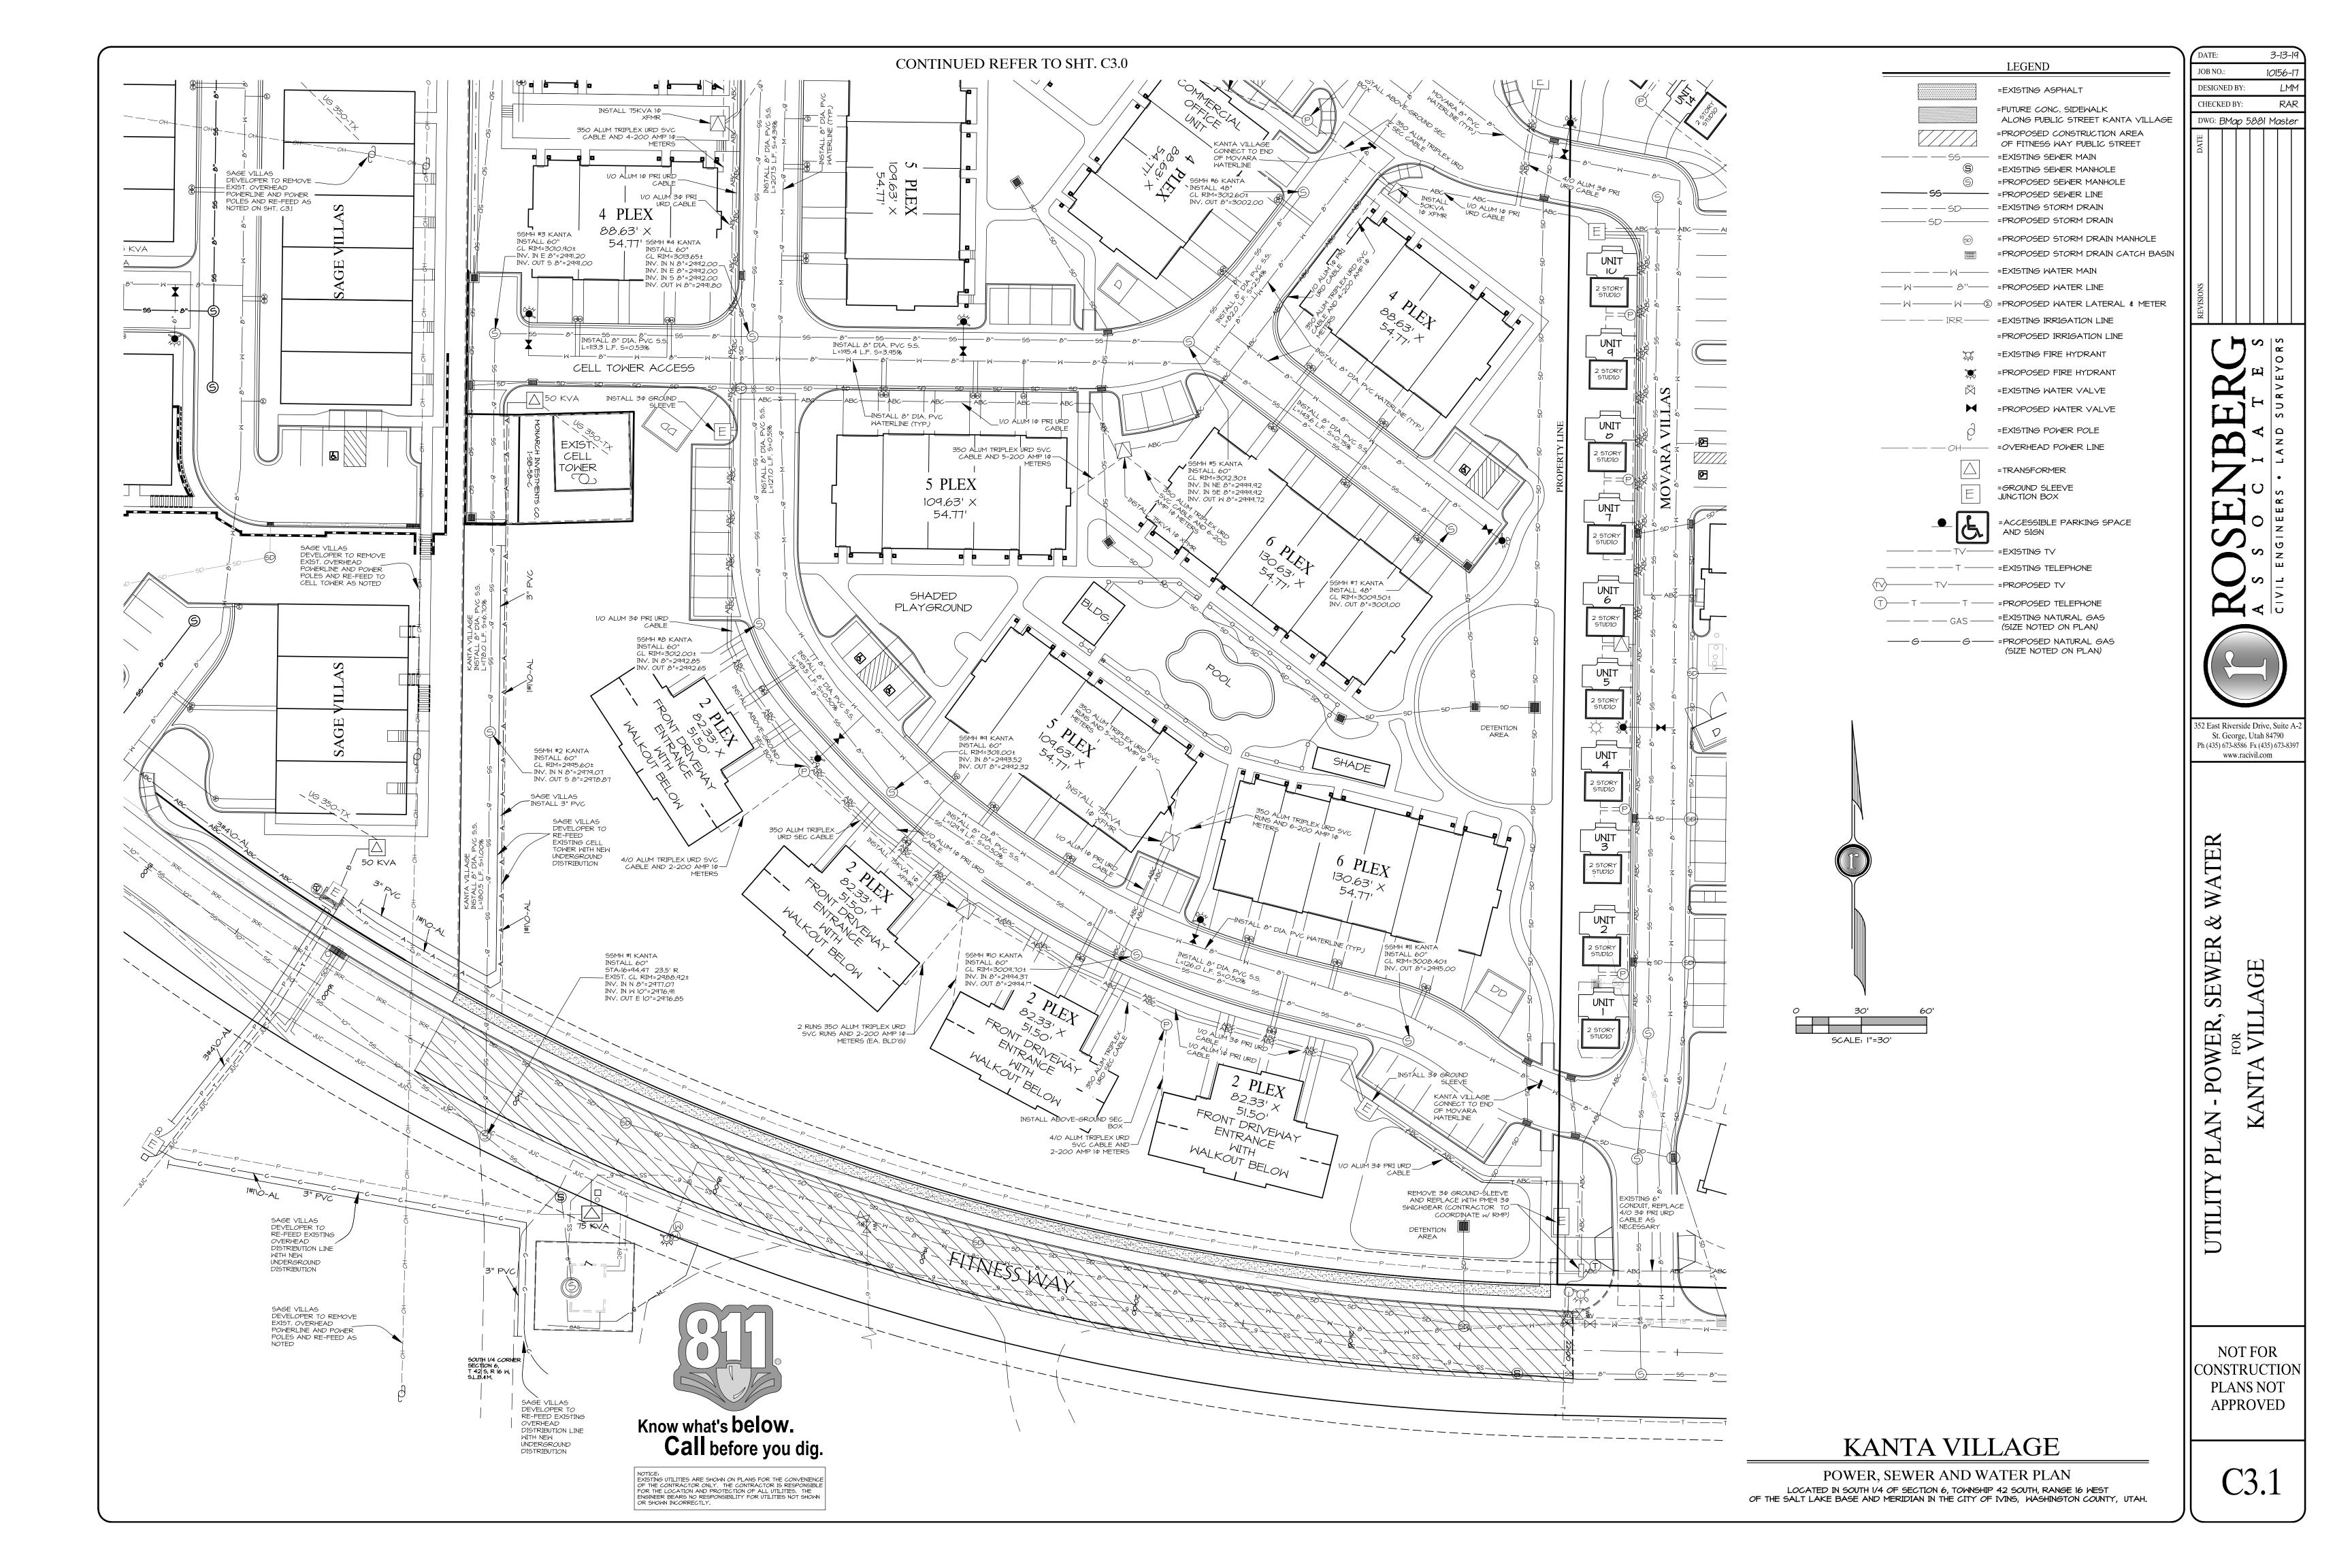

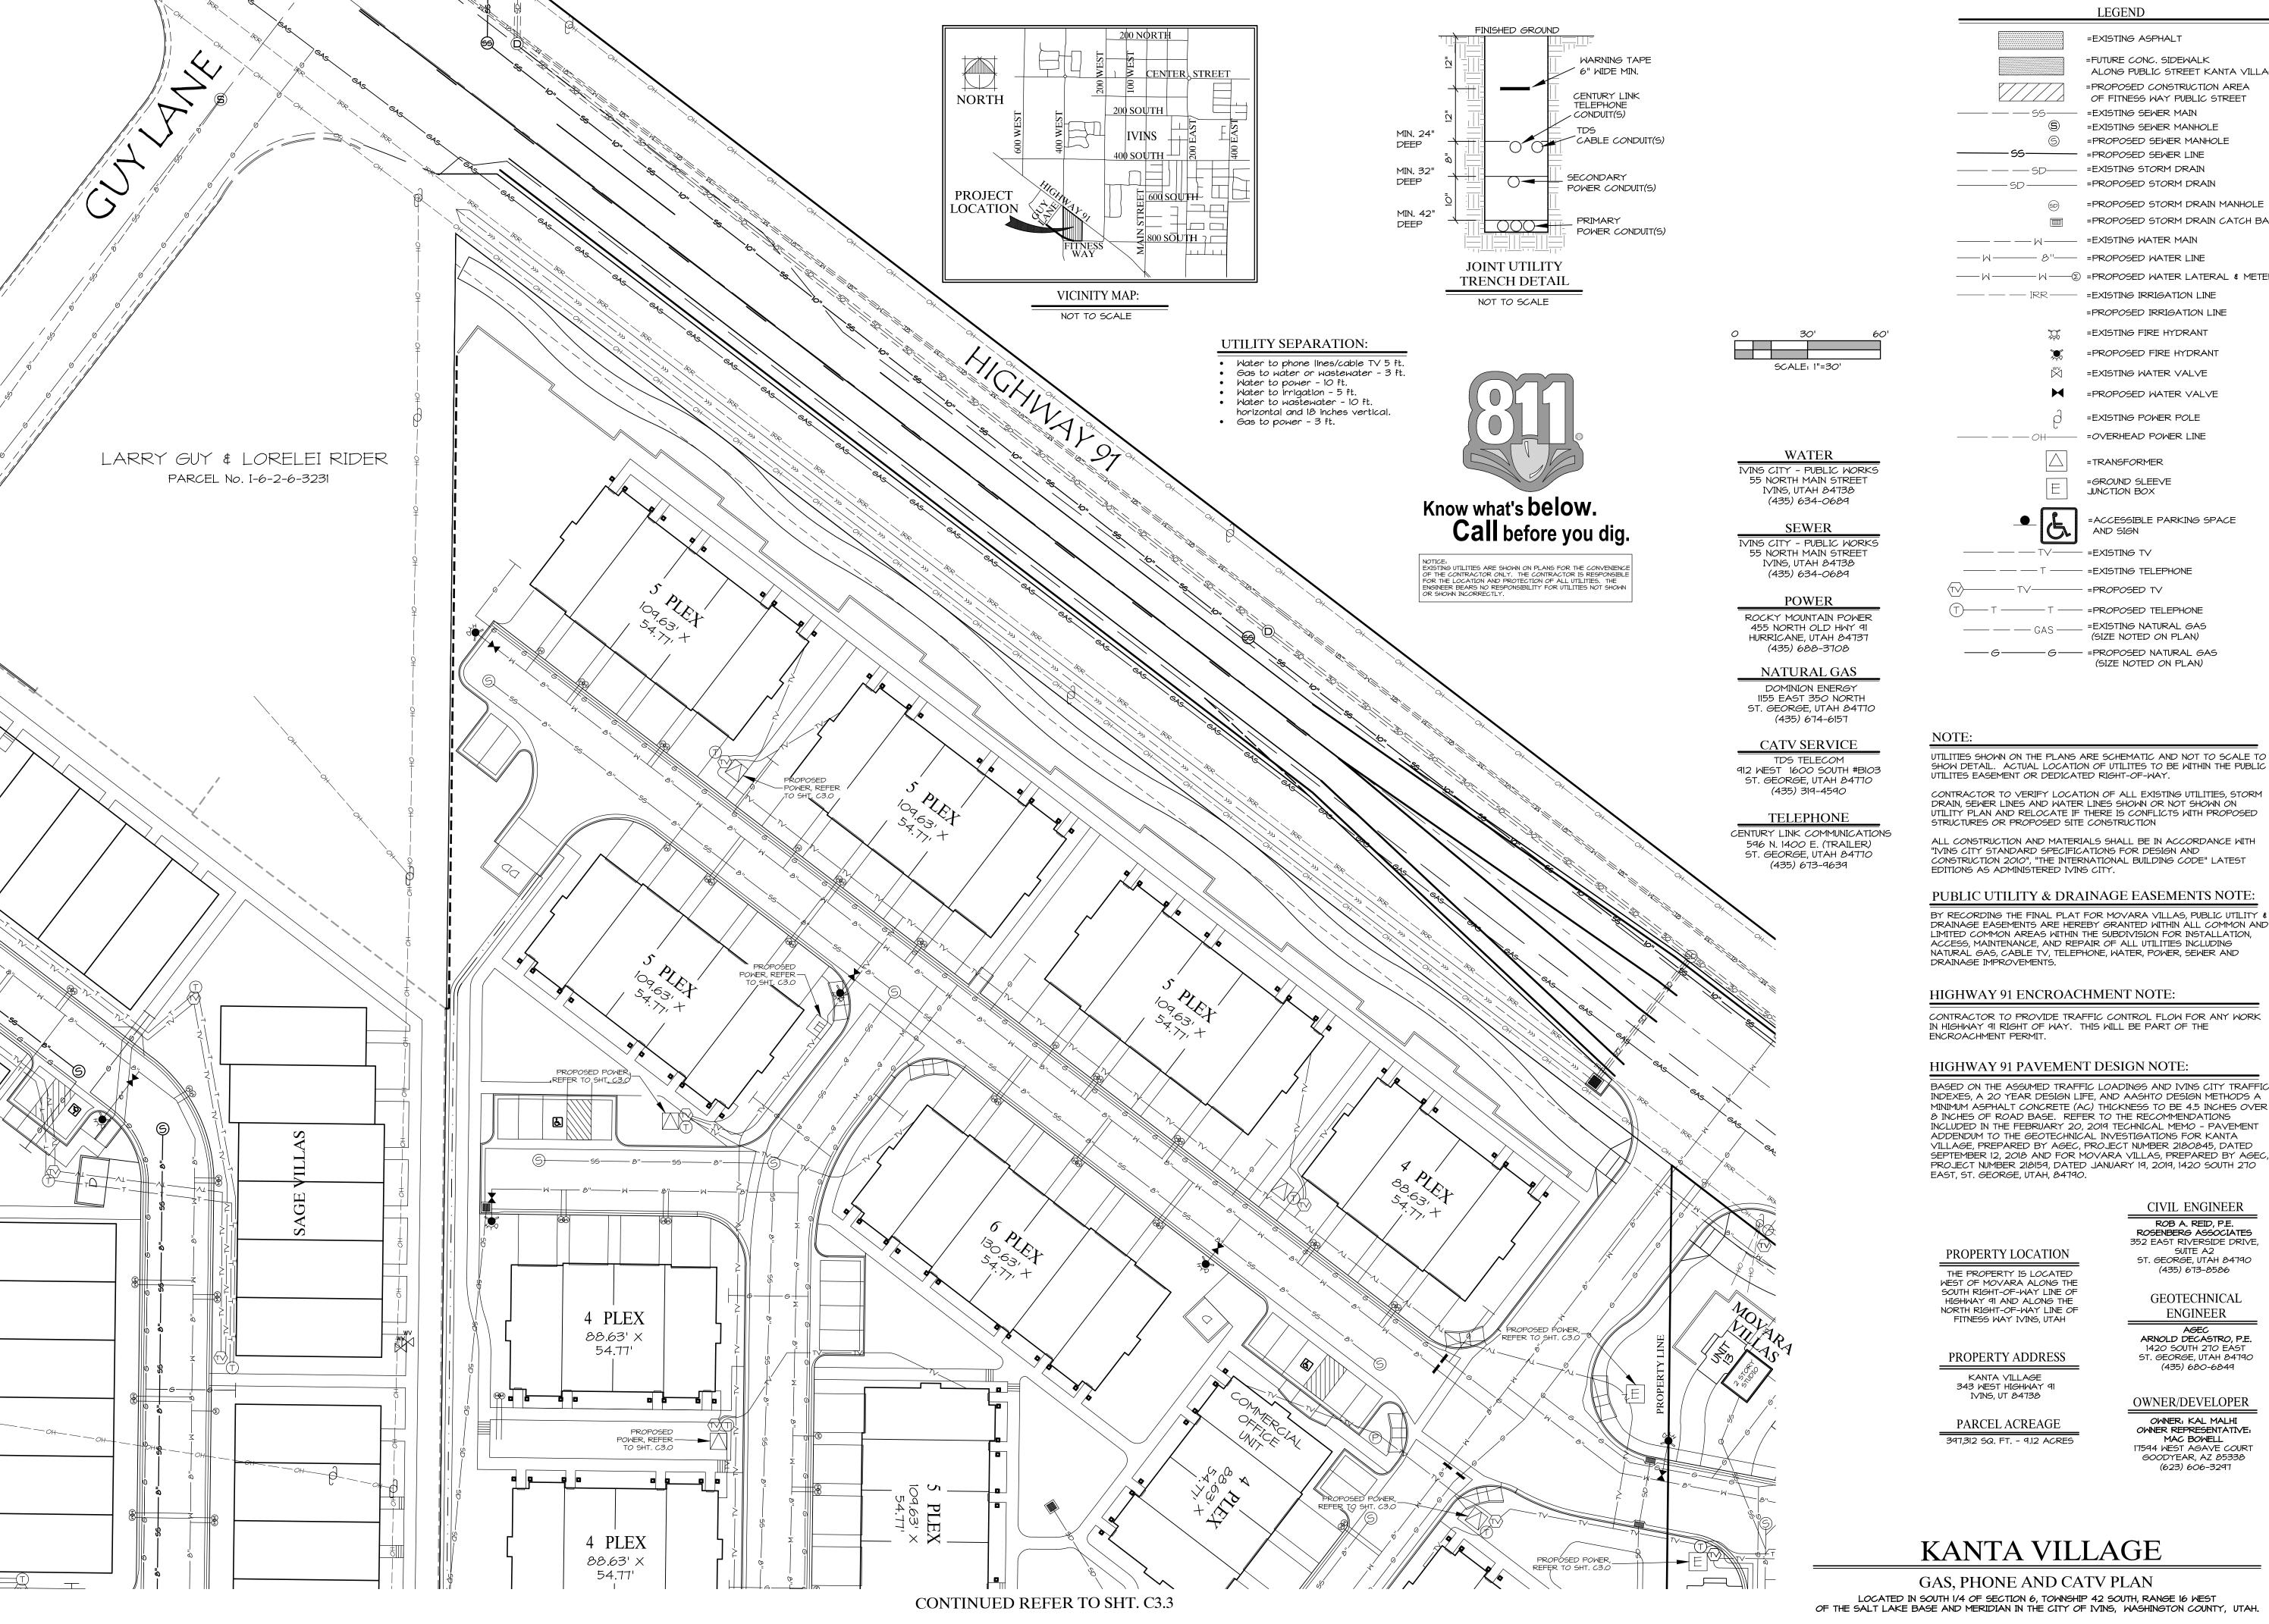

LEGEND JOB NO.: DESIGNED BY: =EXISTING ASPHALT CHECKED BY: =FUTURE CONC. SIDEWALK ALONG PUBLIC STREET KANTA VILLAGE DWG: BMap 5881 Master =PROPOSED CONSTRUCTION AREA OF FITNESS WAY PUBLIC STREET ------ SS----- =EXISTING SEWER MAIN =EXISTING SEWER MANHOLE =PROPOSED SEWER MANHOLE _____ _ SD____ =EXISTING STORM DRAIN =PROPOSED STORM DRAIN MANHOLE =PROPOSED STORM DRAIN CATCH BASIN ____ _ _ _ H____ =EXISTING WATER MAIN =PROPOSED IRRIGATION LINE =EXISTING FIRE HYDRANT =PROPOSED FIRE HYDRANT =EXISTING WATER VALVE =PROPOSED WATER VALVE **=EXISTING POWER POLE** =OVERHEAD POWER LINE =TRANSFORMER =GROUND SLEEVE JUNCTION BOX =ACCESSIBLE PARKING SPACE AND SIGN ----- =EXISTING TV ------ -- T ------ =EXISTING TELEPHONE

10156-17

LMM

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CONSTRUCTION 2010", "THE INTERNATIONAL BUILDING CODE" LATEST

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> CIVIL ENGINEER ROB A. REID, P.E. ROSENBERG ASSOCIATES

> > SUITE A2

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KANTA VILLAGE


GAS, PHONE AND CATV PLAN

LOCATED IN SOUTH 1/4 OF SECTION 6, TOWNSHIP 42 SOUTH, RANGE 16 WEST OF THE SALT LAKE BASE AND MERIDIAN IN THE CITY OF IVINS, WASHINGTON COUNTY, UTAH.

NOT FOR

CONSTRUCTION

PLANS NOT APPROVED

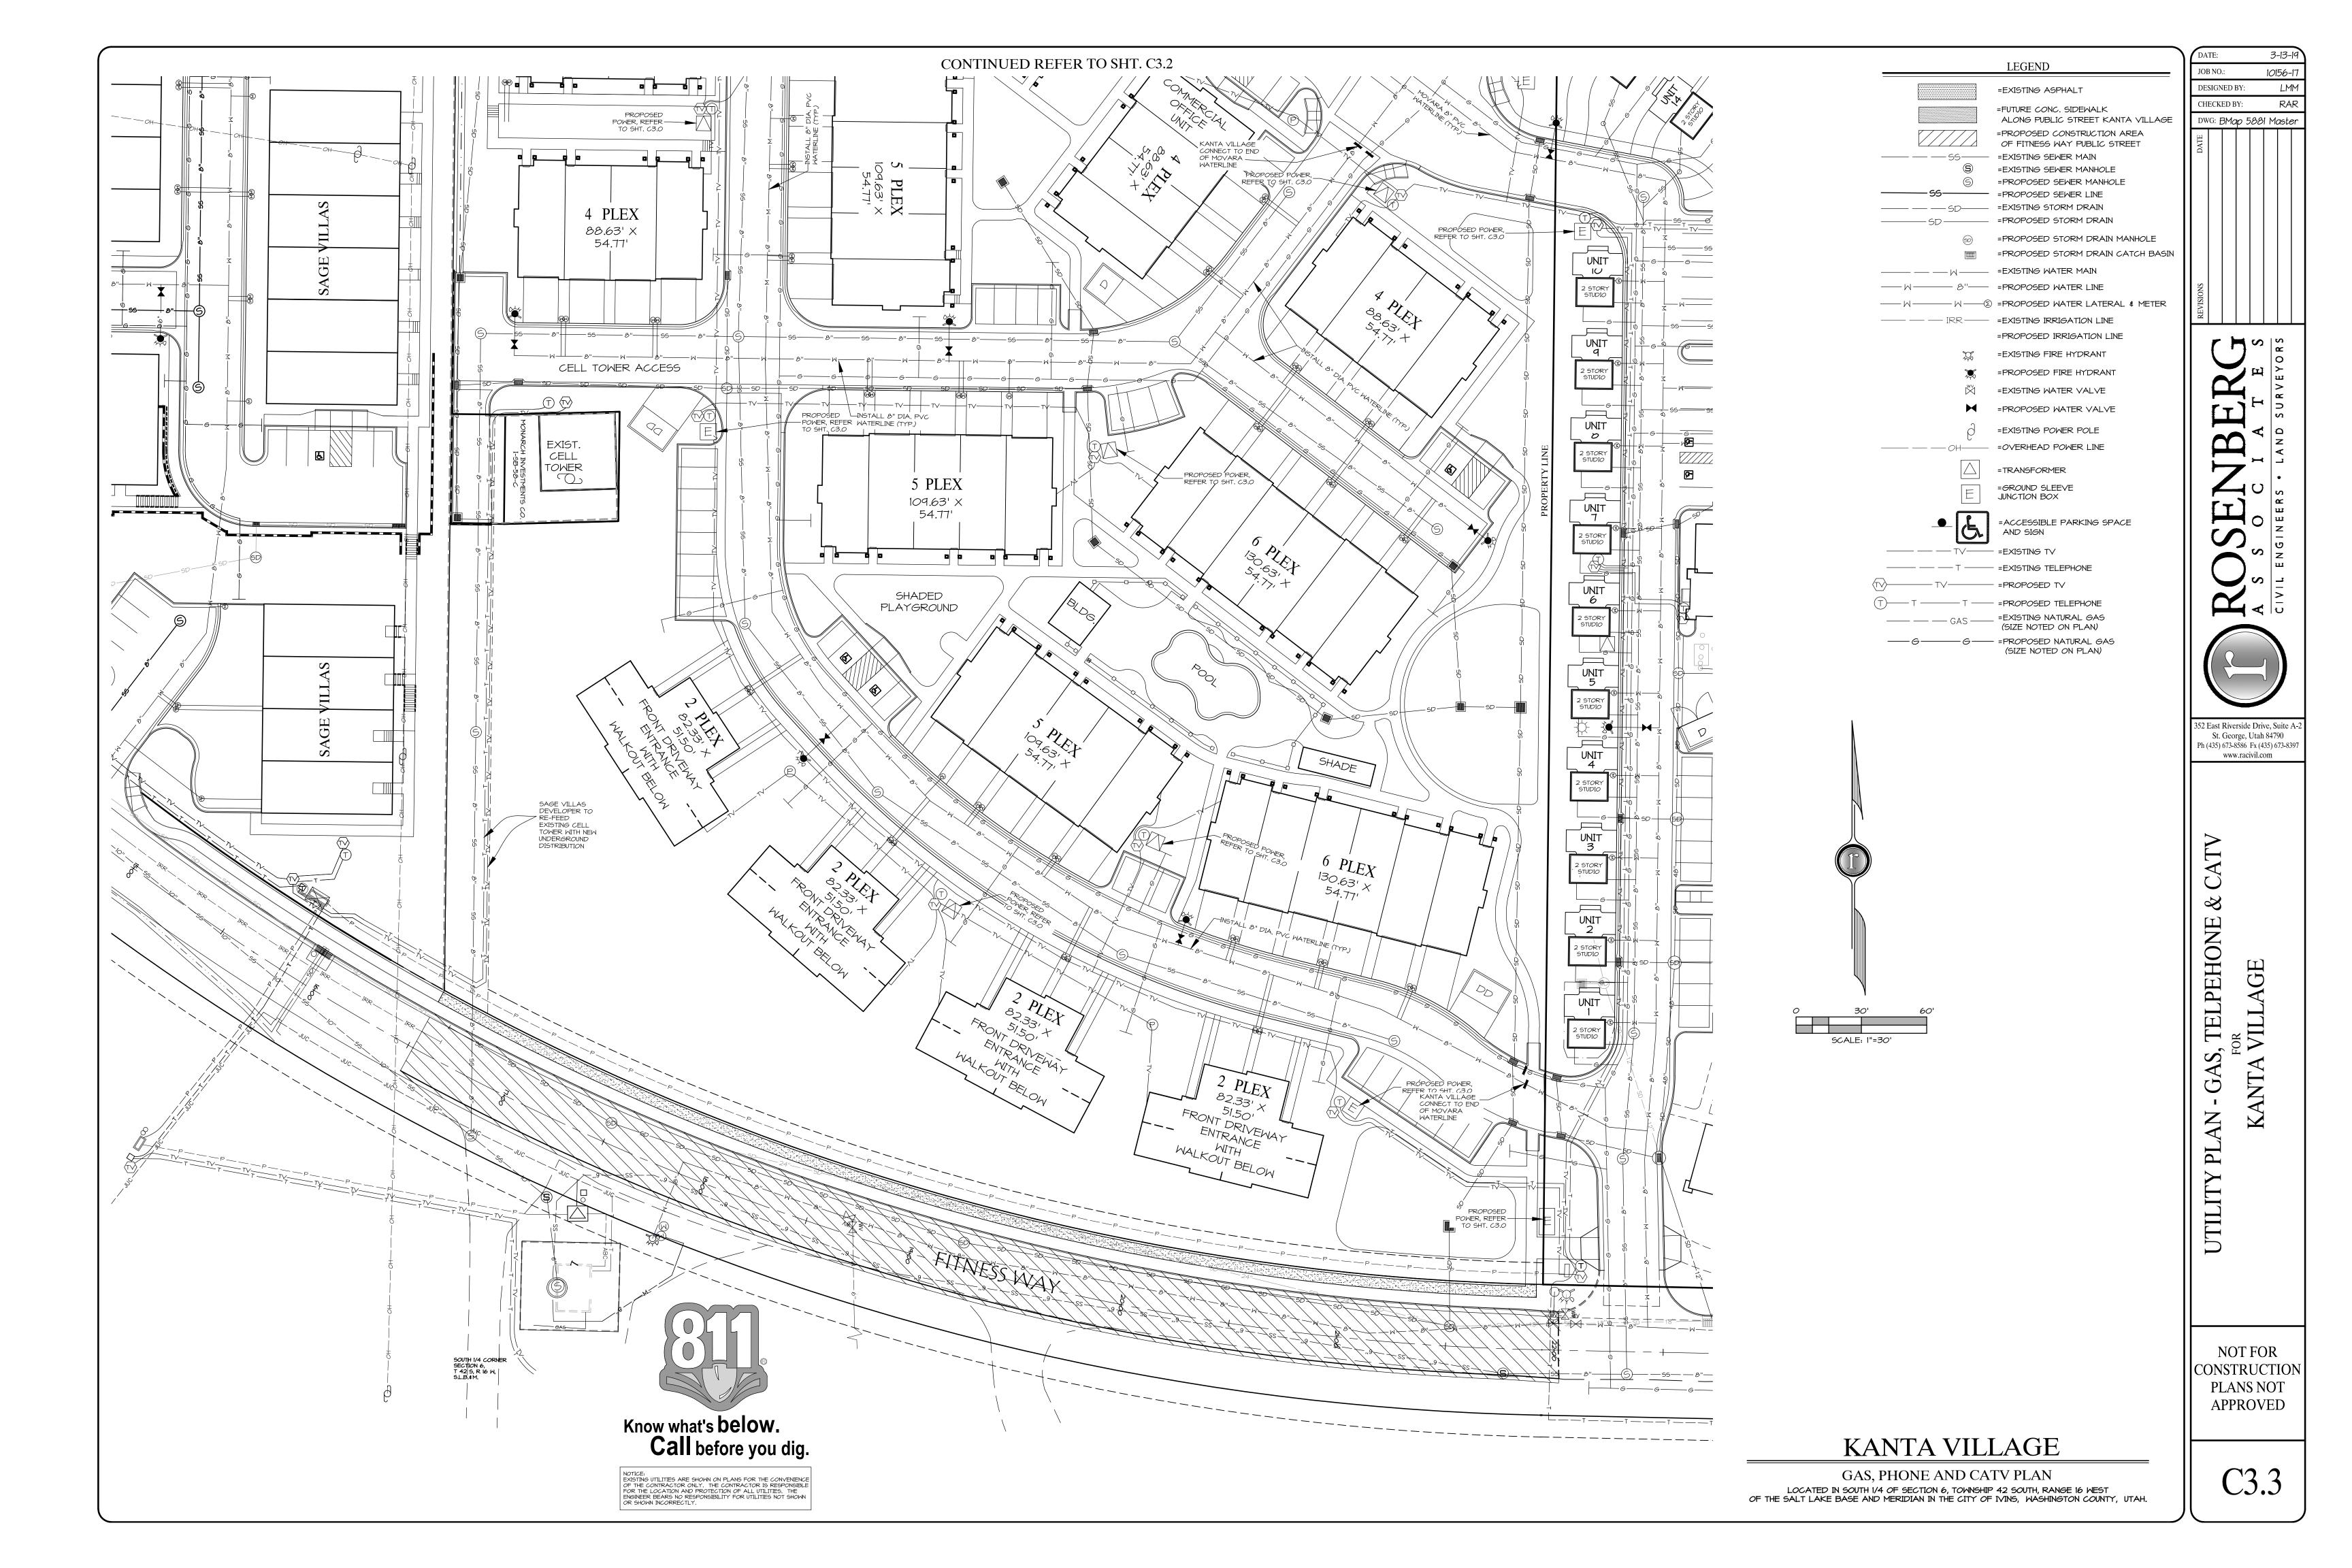

DOMINION ENERGY NOTES:

- DEVELOPER NEEDS TO CONTACT QUESTAR GAS MARKETING DEPARTMENT, PRIOR TO BREAKING GROUND, FOR HAS SIGN UP -> JEFF BURTON @ 435-632-4566
- 2. DEVELOPER WILL BE RESPONSIBLE TO GET ALL COMPACTION TESTS DONE AT DEVELOPERS EXPENSE.
- 3. IF CASINGS/CONDUITS ARE NEEDED, THEY ARE TO BE INSTALLED BY DEVELOPER AT THEIR COST. A MAP WILL BE AVAILABLE AT QUESTAR GAS FOR CASING LOCATIONS (1115 E 350 N ST. GEORGE).
- 4. ALL OF THE 10 FOOT UTILITY EASEMENTS BACK OF SIDEWALK WILL BE GRADED TO WITHIN 6 INCHES OF TOP BACK OF CURB BEFORE HAS LINES WILL BE INSTALLED. ****DEVELOPER WILL BE RESPONSIBLE FOR THE COSTS OF ANY GAS LINES TO BE LOWERED AND/OR RELOCATED AFTER INSTALLATION
- 5. ALL TRENCHES SHALL BE BACKFILLED AND ALL DEBRIS, CONSTRUCTION MATERIALS AND EXCESS DIRT PILES SHALL BE CLEARED AWAY.
- PROPERTY LOT LINES, BACK OF BURN AND GRADE MUST BE STAKED BY DEVELOPER BEFORE HAS WILL BE INSTALLED.
- 7. WATER AND SEWER LINES, CULVERTS OR OTHER HAZARDS NOT CLEARLY NOTICEABLE SHALL BE STAKED BY DEVELOPER.
- 8. FAILURE TO COMPLY WITH THE ABOVE NOTES WILL RESULT IN DELAY OF
- GAS SERVICE TO THIS PROJECT.

 9. CONTACT JEFF BURTON @ 435-632-4566 AT LEAST TWO WEEKS PRIOR TO BEING READY, FOR SCHEDULING OF INSTALLATION.
- 10. *****IMPORTANT NOTICE***** GAS WILL BE PUT ON THE SCHEDULE FOR INSTALLATION WHEN POWER TRENCH IS BURIES, STREETS ARE WITHIN 6 INCHES OF SUB-GRADE AND THE 10 FOOT UTILITY EASEMENT IS GRADED TO TOP BACK OF CURB.
- II. <u>HIGH PRESSURE GAS NOTE:</u> IF HIGH PRESSURE GAS LINES ARE LOCATED IN OR NEAR YOUR DIGGING AREA:
 BEFORE DIGGING PLEASE CALL:
 JERRY JONES @ 435-680-9898 <u>OR</u>
 CORDELL NAYLOR @435-669-2337

CENTURYLINE TELEPHONE NOTES:

632-6553 TO SCHEDULE DELIVERY.

- DEVELOPER TO PLACE CONDUIT IN ALL J.U.C. TRENCH AND STUB UP AT ALL POWER LOCATIONS. CONTACT CENTURY LINK ENGINEER FOR PRINT IF NEEDED.
 CENTURY LINK WILL PROVIDE ALL CONDUIT AND DELIVER TO JOB SITE. CALL
- 3. CONTRACTOR TO INSTALL CONDUIT AND PLACE PULL STRING IN ALL CONDUIT TO
- VERIFY CONDUIT INTEGRITY.

 4. ALL CONDUIT IS 2" UNLESS OTHERWISE NOTED.
- 5. ANY QUESTIONS TO J.U.C. APPROVED PLANS PLEASE CONTACT CENTURY LINK ENGINEER AT 673-9639
- 6. ANY PLANT RELOCATIONS ASSOCIATED WITH PROJECT WILL BE BILLABLE TO OWNER/DEVELOPER. CENTURY LINK ENGINEER MUST BE CONTACTED A MINIMUM OF 4 WEEKS BEFOER RELOCATION IS REQUIRED.
- 7. DEVELOPER IS RESPONSIBLE TO PROVIDE ALL STREET NAMES AND ADDRESSES WITHIN 3 WEEKS OF UTILITY PLAN APPROVAL. FAILURE TO PROVIDE ADDRESSES WILL RESULT IN A DELAY OF SERVICE TO PROJECT.

INTERLINKS / TONAQUINT NETWORKS:

- 1. CONTACT MATT HEATON (801) 930-0444 FOR QUESTIONS.
- 2. TO SCHEDULE SITE VISIT CONTACT MATT HEATON (801) 930-0444 OR GENE MORRIS (435) 705-4977 (45 DAY ADVANCE NOTICE)
- 3. TQN WILL PROVIDE CONDUIT IN EXISTING OPEN TRENCH. PLEASE CONTACT MATT OR GENE 10 DAYS BEFORE TRENCH OPENS.

TDS TELECOM CATV NOTES:

- THE DEVELOPER WILL PROVIDE ALL REQUIRED TRENCH WITHIN THE PROJECT. ANY MODIFICATIONS ALONG THE PERIPHERY TO FEED THIS PROJECT WILL BE BILLED TO THE DEVELOPER.
- 2. TDS WILL PROVIDE CONDUITS. CONTACT **DAVID TRAUNTVEIN** AT (435)
 103-8932 AT LEAST TWO WEEKS PRIOR TO OPENING TRENCH TO SCHEDULE
- 3. FOR MDU'S AND COMMERCIAL UNITS THERE MUST BE ONE RG-6 COAXIAL CABLE COMING FROM EACH UNIT TO THE DEMARC LOCATION.
- 4. ANY QUESTIONS REGARDING SERVICE SHOULD BE DIRECTED TOWARD DAVID TRAUNTVEIN WITH TDS AT (435) 703-8932.
- 5. RELOCATION OF NEW OR EXISTING TDS FACILITIES WILL BE BILLABLE TO THE DEVELOPER/CONTRACTOR.
- 6. ANY MODIFICATIONS AFTER CONDUIT/CABLE PLACEMENT WILL BE BILLABLE TO THE DEVELOPER/CONTRACTOR AS WILL DAMAGES CAUSED BY OTHER CONTRACTORS WORKING FOR THE DEVELOPER ON THIS PROJECT.

PUBLIC UTILITY & DRAINAGE EASEMENTS NOTE:

BY RECORDING THE FINAL PLAT FOR MOVARA VILLAS, PUBLIC UTILITY & DRAINAGE EASEMENTS ARE HEREBY GRANTED WITHIN ALL COMMON AND LIMITED COMMON AREAS WITHIN THE SUBDIVISION FOR INSTALLATION, ACCESS, MAINTENANCE, AND REPAIR OF ALL UTILITIES INCLUDING NATURAL GAS, CABLE TV, TELEPHONE, WATER, POWER, SEWER AND DRAINAGE IMPROVEMENTS.

GENERAL UTILITY NOTES:

- I. THE CONTRACTOR SHALL BE RESPONSIBLE FOR THE LOCATION AND PROTECTION OF ALL EXISTING UNDERGROUND UTILITIES DURING CONSTRUCTION.
- THE CONTRACTOR IS REQUIRED TO CALL IVINS CITY FOR INSPECTION OF ALL IMPROVEMENTS RELATED TO THIS PROJECT.
- 3. THE CONTRACTOR IS REQUIRED TO OBTAIN AN ENCROACHMENT PERMIT FOR ANY WORK DONE IN A PUBLIC RIGHT-OF-WAY.
- 4. ANY NECESSARY MODIFICATIONS SHALL BE APPROVED BY THE DESIGN ENGINEER PRIOR TO CONSTRUCTION.
- 5. UNLESS OTHERWISE ON THESE PLANS ALL CONSTRUCTION SHALL CONFORM TO THE "IVINS CITY STANDARD SPECIFICATIONS FOR DESIGN AND CONSTRUCTION 2010", "THE UNIFORM PLUMBING CODE", AND THE "UNIFORM BUILDING CODE" LATEST EDITIONS AS ADMINISTERED BY IVINS
- 6. CONTRACTOR TO VERIFY LOCATION OF ALL EXISTING UTILITY, STORM DRAIN AND FIRE SERVICE LINES SHOWN OR NOT SHOWN ON UTILITY PLAN.
- 7. ALL EXCAVATIONS AND GRADING SHALL BE IN ACCORDANCE WITH THE REQUIREMENTS OF IVINS CITY. SPECIFICALLY APPENDIX "J" OF THE INTERNATIONAL BUILDING CODE," LATEST EDITION AND REQUIREMENTS INCLUDED IN THE FEBRUARY 20, 2019 TECHNICAL MEMO PAVEMENT ADDENDUM TO THE GEOTECHNICAL INVESTIGATIONS FOR KANTA VILLAGE, PREPARED BY AGEC, PROJECT NUMBER 2180845, DATED SEPTEMBER 12, 2018 AND FOR MOVARA VILLAS, PREPARED BY AGEC, PROJECT NUMBER 2181595, DATED JANUARY 19, 2019, 1420 SOUTH 270 EAST, ST. GEORGE, UTAH. 84790.

WATER NOTES:

- 1. ALL WATERLINE WORKS MUST BE INSTALLED BY A CONTRACTOR THAT HAS BEEN PRE-QUALIFIED BY IVINS CITY WATER DEPARTMENT.
- 2. ALL CONSTRUCTION SHALL CONFORM TO THE "IVINS CITY STANDARD SPECIFICATIONS FOR DESIGN AND CONSTRUCTION 2010", "THE INTERNATIONAL PLUMBING CODE", AND THE "UNIFORM BUILDING CODE" LATEST EDITION AS ADMINISTERED BY IVINS CITY.
- 3. CONTRACTOR SHALL POTHOLE ALL PIPELINES AND VERIFY LOCATION AND DEPTH PRIOR TO PROCEEDING WITH ANY BUILDING OR PIPELINE CONSTRUCTION.
- 4. THE POTABLE WATER SUPPLY TO LAWN IRRIGATION SYSTEMS SHALL BE PROTECTED AGAINST BACKFLOW PER THE INTERNATIONAL PLUMBING CODE (IPC) SECTION 608.16.5 AND FOR FIRE SPRINKLER SYSTEMS PER (IPC) 608.16.4.
- 5. APPROVED BACKFLOW PREVENTION DEVICES SHALL BE INSTALLED FOR ALL IRRIGATION AND PRIVATE FIRE SERVICE.
- I4 GAUGE WIRE SHALL BE TAPED TO ALL WATER LINES FOR LOCATING PURPOSES. THE WIRE SHALL ALSO BE BROUGHT UP AT EACH VALVE BOX AND HYDRANT.
- 7. THRUST RESTRAINT ON THE NEW PIPELINE WILL BE AS SHOWN ON THE DETAILS. USE MEGA-LUG ON THE FITTINGS AND FIELD LOCK GASKETS ON THE REQUIRED LENGTH OF RESTRAINED PIPE.
- ASPHALT REPLACED OVER THE PIPE TRENCHING IS TO MATCH EXISTING PAVEMENT DEPTHS WITH A 6" OVER CUT FROM EDGE OF THE TRENCH LINE ON EACH SIDE OF THE TRENCH.
- ALL EXISTING SERVICE LINES OR UNUSED STUB LINES THAT WILL BE ABANDONED.

 10. ANY CHANGES MADE IN THE FIELD MUST BE FIRST APPROVED AND

9. CONTRACTORS SHALL CUT OFF AND CAP (BACK AT THE WATER MAIN),

- DOCUMENTED BY IVINS CITY WATER SERVICES ENGINEER.

 11. FIRE HYDRANTS AND WATER METERS SHALL BE INSTALLED 3 FT. BEHIND
- BACK OF CURB.

 12. CONSTRUCT WATERLINE TO HAVE MINIMUM 3.5 FT COVER FROM EXISTING

WASTE WATER NOTES:

- 1. NO SEWER UNDER 9' DEEP UNLESS APPROVED BY IVINS CITY.
- ANY SEWERS NOT IN PUBLIC STREETS SHALL SHOW RECORDED EASEMENTS.
- 3. BUILDINGS MAY REQUIRE INTERCEPTORS AT A LATER DATE.
- ALL SEWER MANHOLES SHALL HAVE IVINS CITY LOGO LIDS FOR FINAL INSPECTION.
 100' MAXIMUM SPACE BETWEEN SEWER LATERAL CLEANOUTS.
- 6. PRIVATE SEWER LINES TO BE MAINTAINED BY OWNER.

POWER NOTES:

- CONTACT ROCKY MOUNTAIN POWER FOR EXACT DESIGN.
- 2. CONTRACTOR TO FOLLOW ALL BLUE STAKES PROTOCOLS.
- 3. THE POWER DESIGN ON THIS UTILITY PLAN IS CONSIDERED BY ROCKY MOUNTAIN POWER ENERGY SERVICES AS PRELIMINARY AND NON-BIDABLE UNTIL ACCOMPANIED BY A JUC APPROVAL STAMP.
- 4. ALL PRIMARY UNDERGROUND POWER WORK/INSTALLATION MUST BE COMPLETED BY A CONTRACTOR THAT HAS BEEN PRE-QUALIFIED BY ROCKY MOUNTAIN POWER STANDARDS. ALL OVER-HEAD WORK/INSTALLATION MUST BE COMPLETED BY ROCKY MOUNTAIN POWER
- 5 ALL WORK DONE BY ROCKY MOUNTAIN POWER WILL BE PREPAID BY THE DEVELOPER.
- 6. IT IS THE RESPONSIBILITY OF THE DESIGN ENGINEER TO PROVIDE LOCATION AND ELEVATION OF ALL EXISTING AND DESIGN UNDERGROUND/OVER-HEAD UTILITIES AND STRUCTURES THAT WILL IMPACT THE ROCKY MOUNTAIN POWER DESIGN.
- 7. ALL JUC TRENCHES WILL BE BACKFIELD AND COMPACTED IN 6" TO 8" LIFTS TO A COMPACTION OF 95% IN ROADWAYS/SIDEWALKS AND 90% BEHIND SIDEWALK. TESTING IS TO BE DONE AT MIDDLE AND TOP OF
- ALL CHANGES TO EXISTING GRADES NEAR EXISTING POWER UTILITIES
 MUST BE APPROVED BY ROCKY MOUNTAIN POWER PRIOR TO
 CONSTRUCTION.
- 9. ANY IN FIELD CHANGES TO JUC APPROVED POWER DESIGN WILL BE AT THE DEVELOPER'S EXPENSE AND MUST BE PRE-APPROVED AND DOCUMENTED BY ROCKY MOUNTAIN POWER PRIOR TO INSTALLATION.

JOB NO.: 10156-17
DESIGNED BY: LMM
CHECKED BY: RAR
DWG: BMap 5881 Master
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3-13-19

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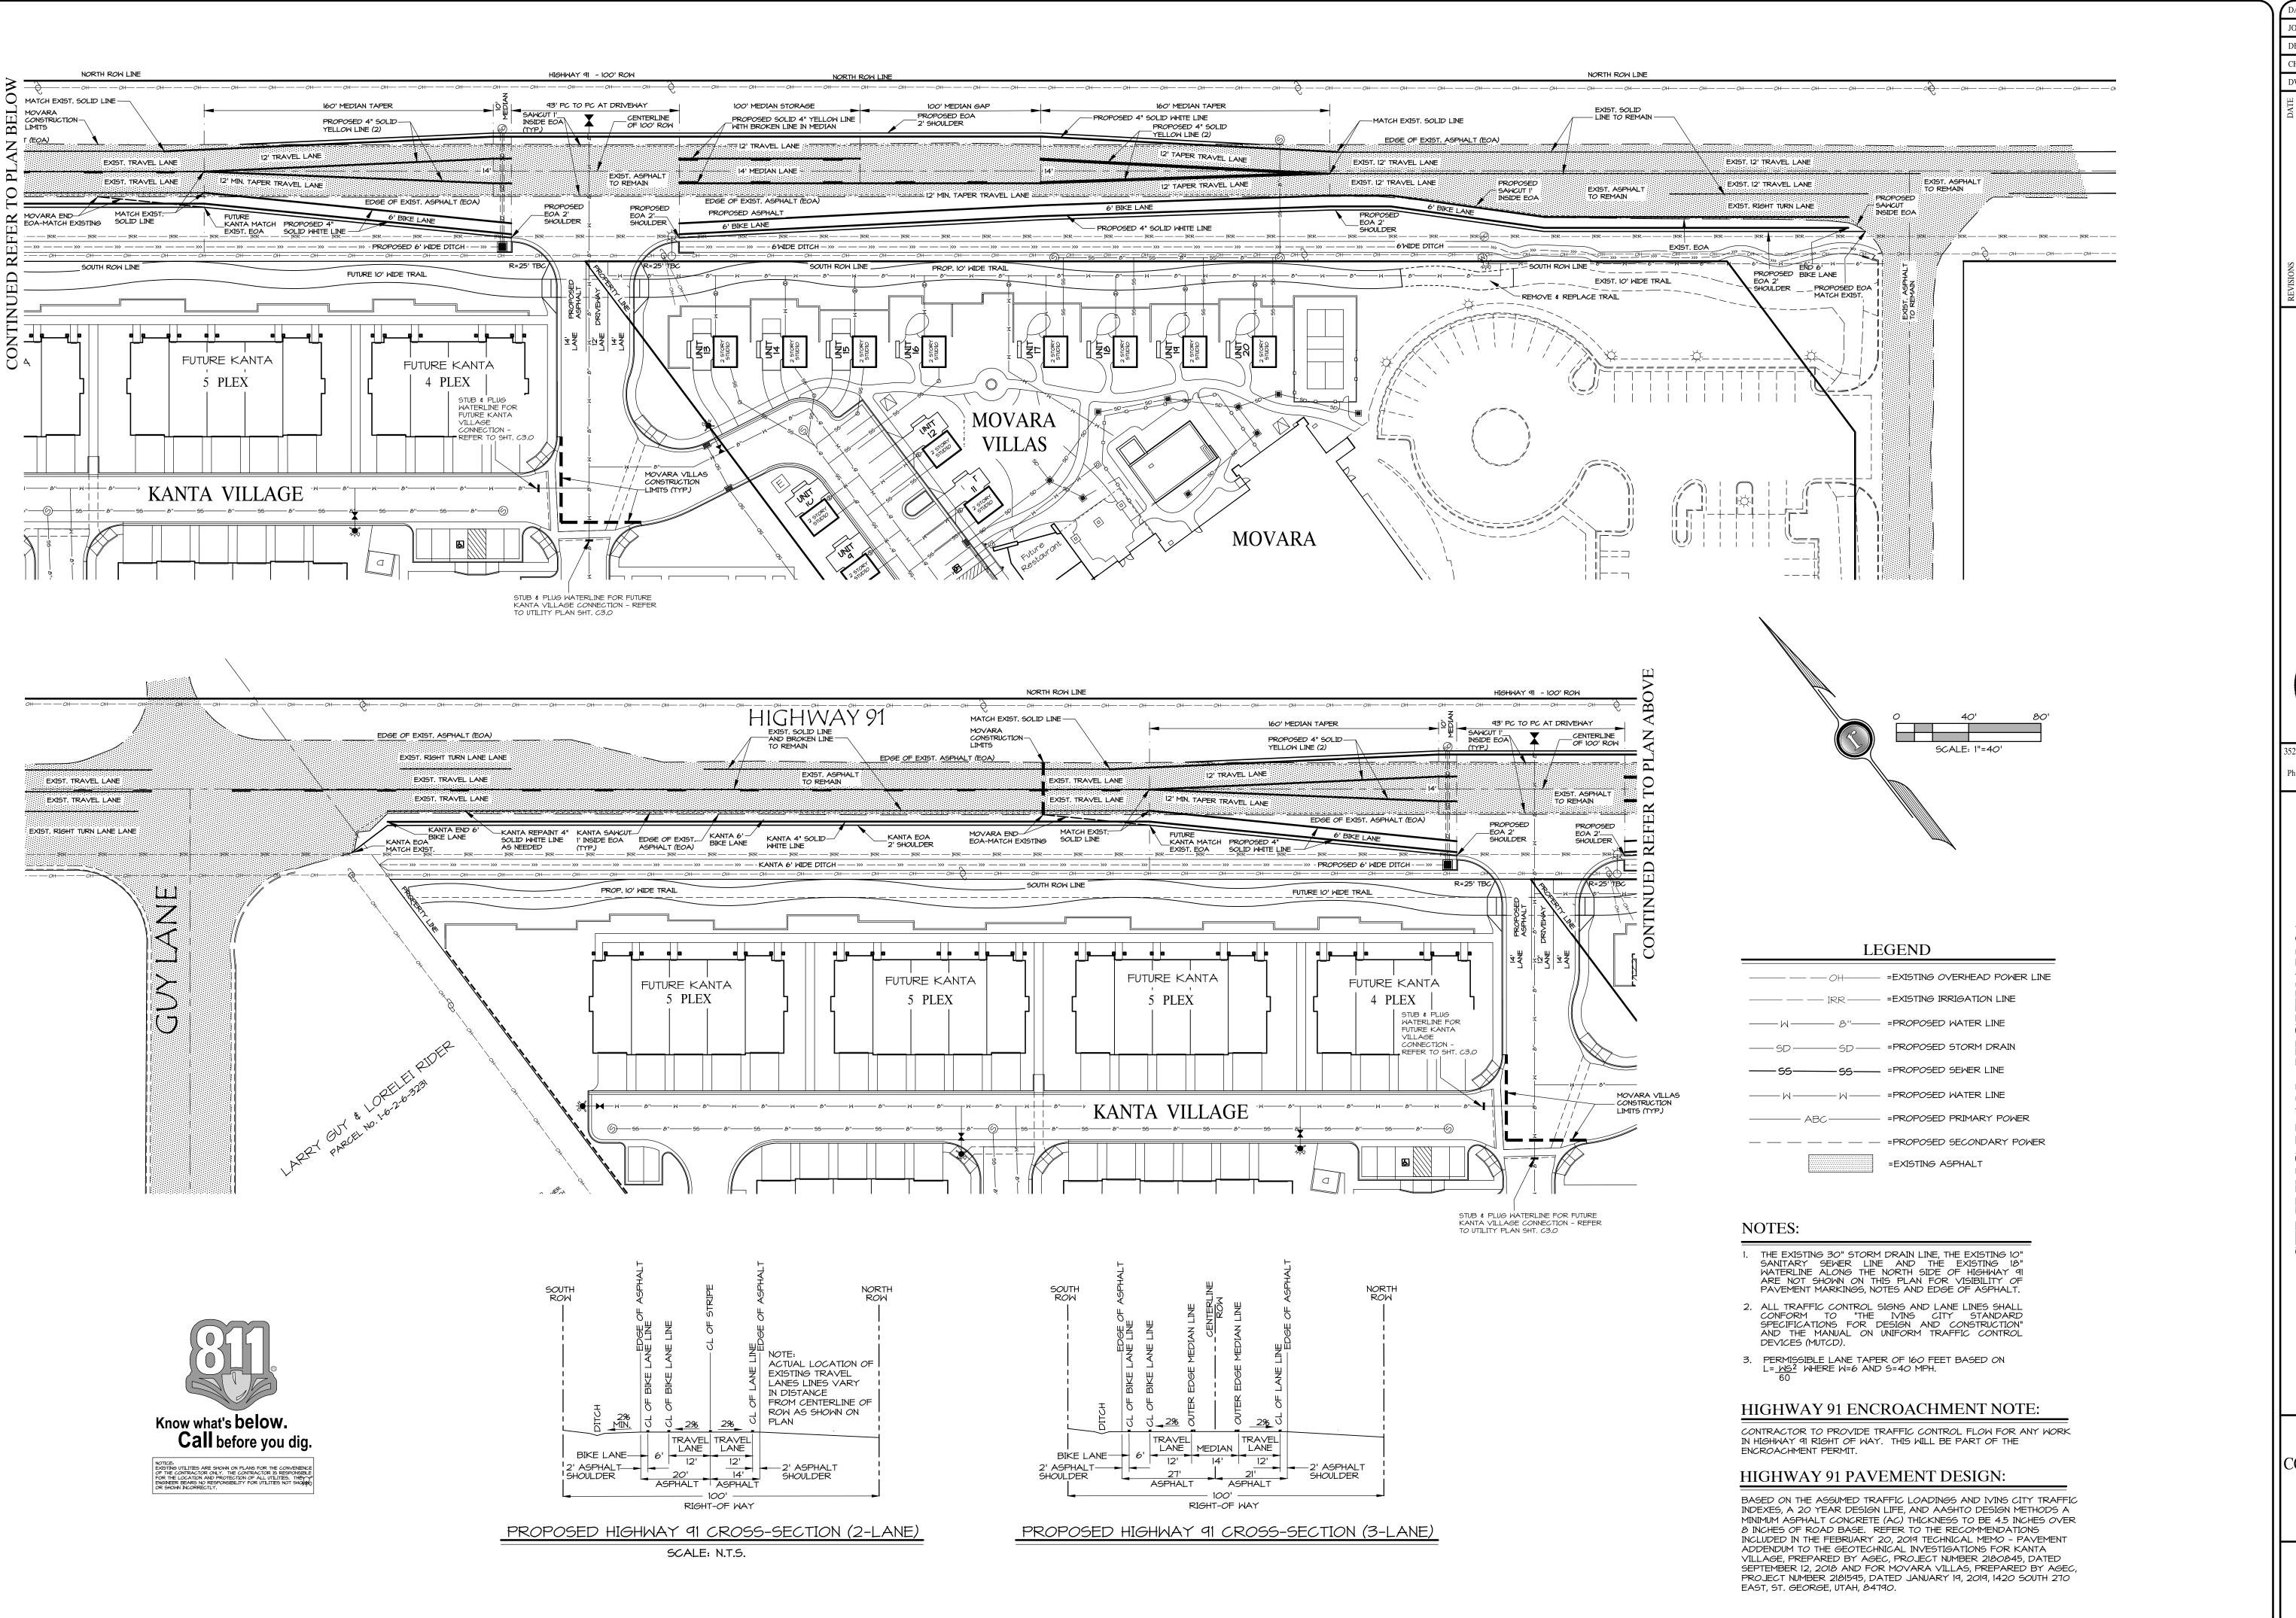


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UTILITY NOTES
FOR
KANTA VILLAGE

NOT FOR CONSTRUCTION PLANS NOT APPROVED

C3.4



JOB NO.: 5881-18

DESIGNED BY: LMM

CHECKED BY: RAR

DWG: BaseMap 5881

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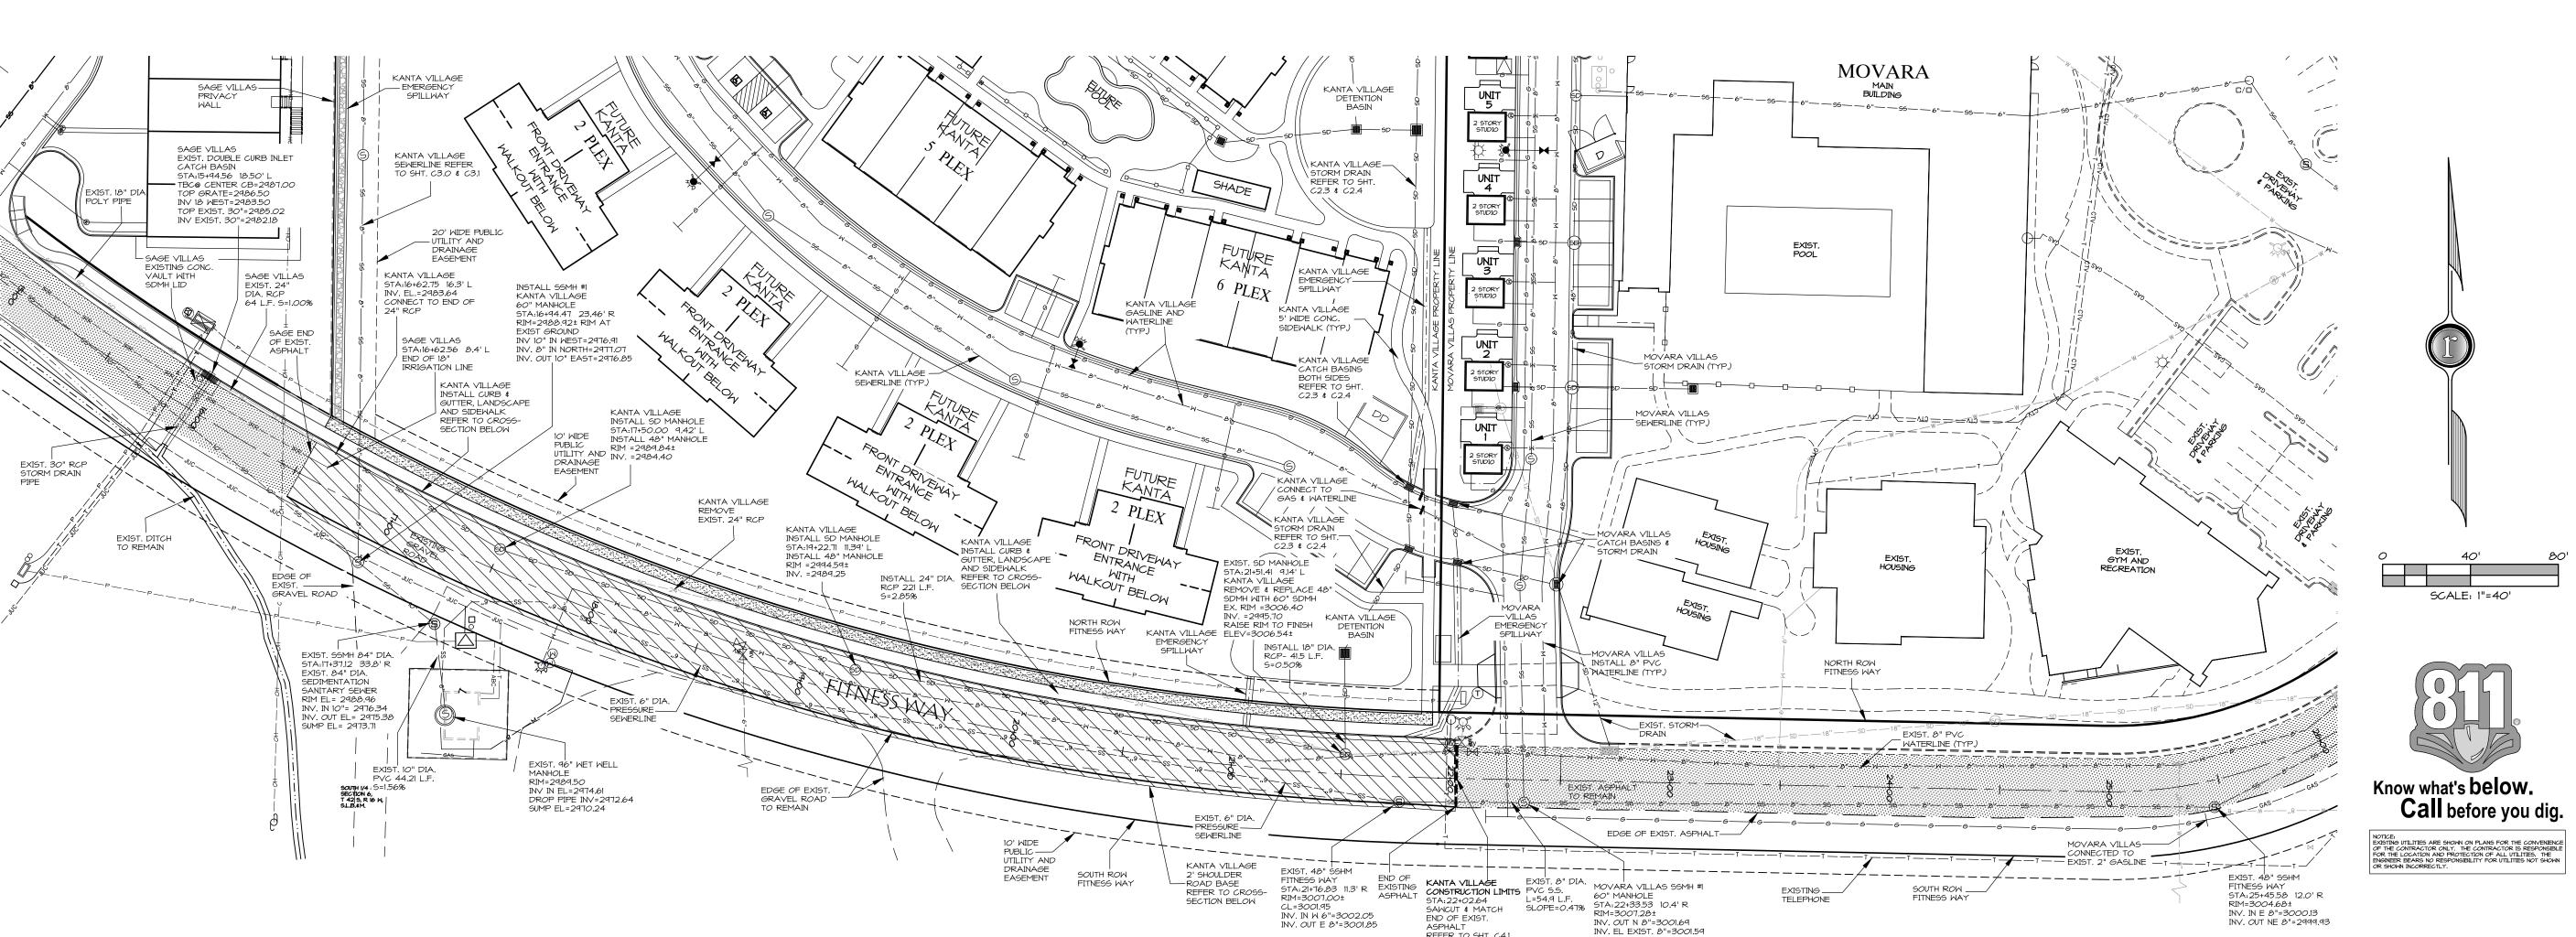


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STRIPING PLAN - HIGHWAY 91 FOR TA VILLAGE & MOVARA VILLAS

NOT FOR CONSTRUCTION PLANS NOT APPROVED

C4.0




FITNESS WAY NOTE: FOR FITNESS WAY PROFILE REFER TO SHT. C4.1


PLAN VIEW FITNESS WAY SCALE: 1"=40'

REFER TO SHT. C4.1

NOTES:

- 1. THE CONTRACTOR SHALL BE RESPONSIBLE FOR THE EXACT LOCATION AND PROTECTION OF ALL EXISTING UNDERGROUND UTILITIES DURING CONSTRUCTION. CONTRACTOR SHALL ADJUST EXISTING WATER VALVES AND MANHOLES TO FINISH GRADE. REFER TO "IVING CITY STANDARD SPECIFICATIONS FOR DESIGN AND CONSTRUCTION 2010".
- THE CONTRACTOR IS REQUIRED TO CALL IVINS CITY FOR INSPECTION OF ALL IMPROVEMENTS RELATED TO THIS PROJECT.
- 3. THE CONTRACTOR IS REQUIRED TO OBTAIN AN ENCROACHMENT PERMIT FOR ANY WORK DONE IN A PUBLIC RIGHT-OF-WAY.
- 4. ANY NECESSARY MODIFICATIONS SHALL BE APPROVED BY THE DESIGN ENGINEER PRIOR TO CONSTRUCTION.
- 5. UNLESS OTHERWISE ON THESE PLANS ALL CONSTRUCTION SHALL CONFORM TO THE "IVINS CITY STANDARD SPECIFICATIONS FOR DESIGN AND CONSTRUCTION 2010", "THE UNIFORM PLUMBING CODE", AND THE "UNFORM BUILDING CODE" LATEST EDITIONS AS ADMINISTERED BY IVINS
- 6. CONTRACTOR TO VERIFY LOCATION OF ALL EXISTING UTILITY, STORM DRAIN AND FIRE SERVICE LINES SHOWN OR NOT SHOWN ON UTILITY PLAN.
- 7. ALL KANTA VILLAGE ONSITE EXCAVATIONS AND GRADING SHALL BE IN ACCORDANCE WITH THE REQUIREMENTS OF IVINS CITY AND THE SPECIFICATIONS AND REQUIREMENTS INCLUDED IN THE GEOTECHNICAL INVESTIGATION FOR KANTA VILLAGE, PREPARED BY AGEC, PROJECT NUMBER 2180845, DATED SEPTEMBER 12, 2018, 1420 SOUTH 270 EAST, ST. GEORGE, UTAH, 84790.
- 8. FITNESS WAY EXCAVATIONS AND GRADING SHALL BE IN ACCORDANCE WITH THE REQUIREMENTS OF IVINS CITY AND THE SPECIFICATIONS AND REQUIREMENTS INCLUDED IN THE FEBRUARY 20, 2019 TECHNICAL MEMO PAVEMENT ADDENDUM TO THE GEOTECHNICAL INVESTIGATIONS FOR KANTA VILLAGE, PREPARED BY AGEC, PROJECT NUMBER 2180845, DATED SEPTEMBER 12, 2018, AND FOR MOVARA VILLAS, PREPARED BY AGEC, PROJECT NUMBER 2181595, DATED JANUARY 19, 2019, 1420 SOUTH 270 FAST ST GEORGE UTAH 84790 270 EAST, ST. GEORGE, UTAH, 84790.

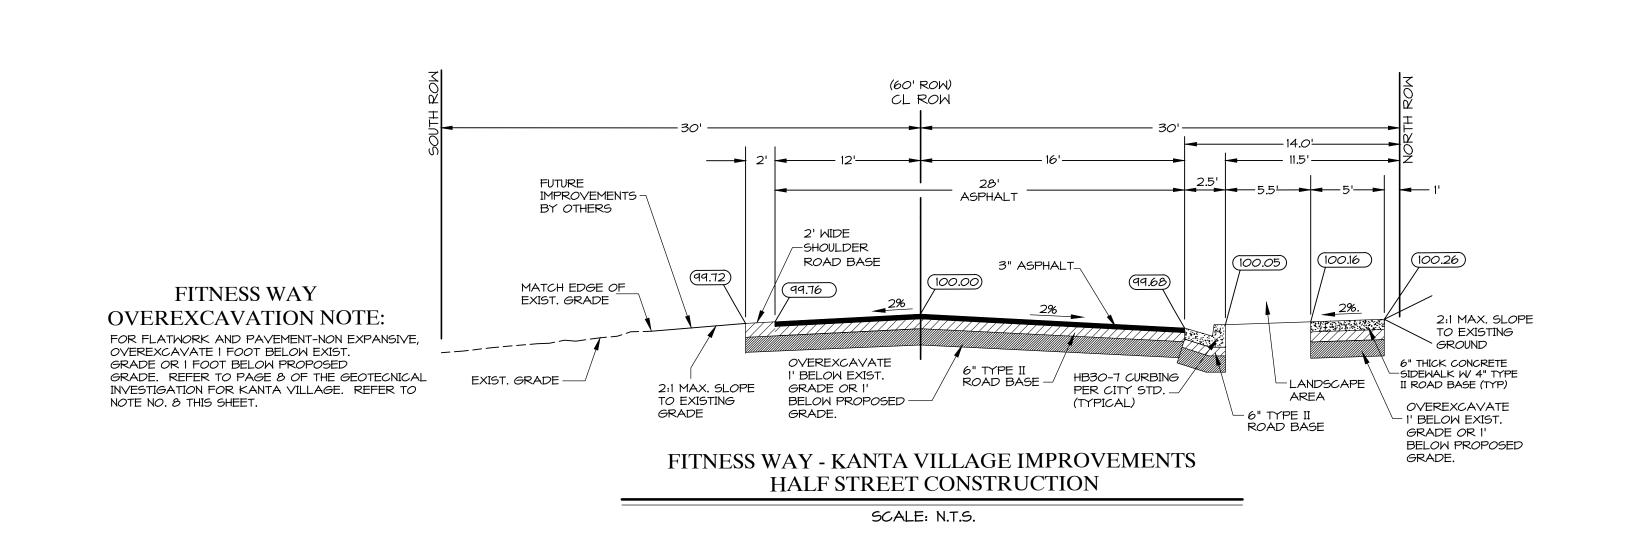

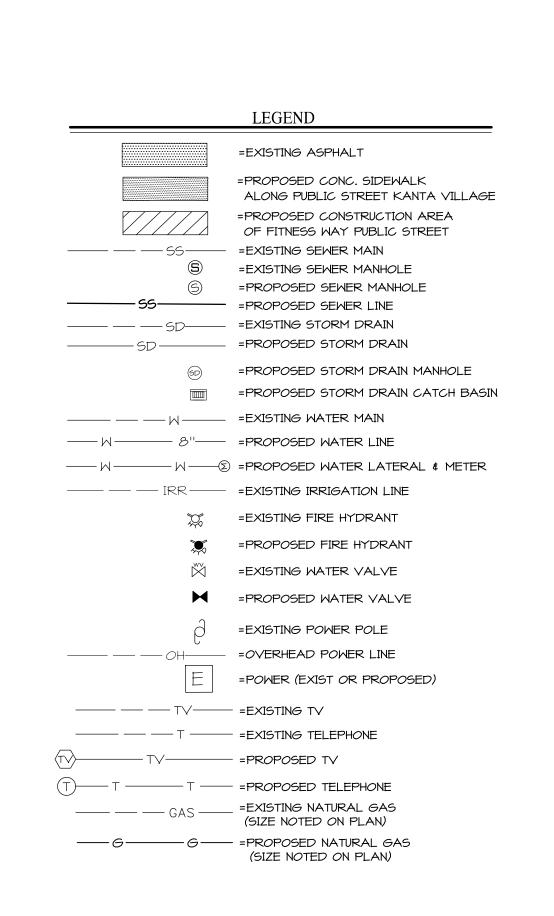

JOB NO.: 5881-18-017 DESIGNED BY: CHECKED BY: DWG: BM 5881 Master





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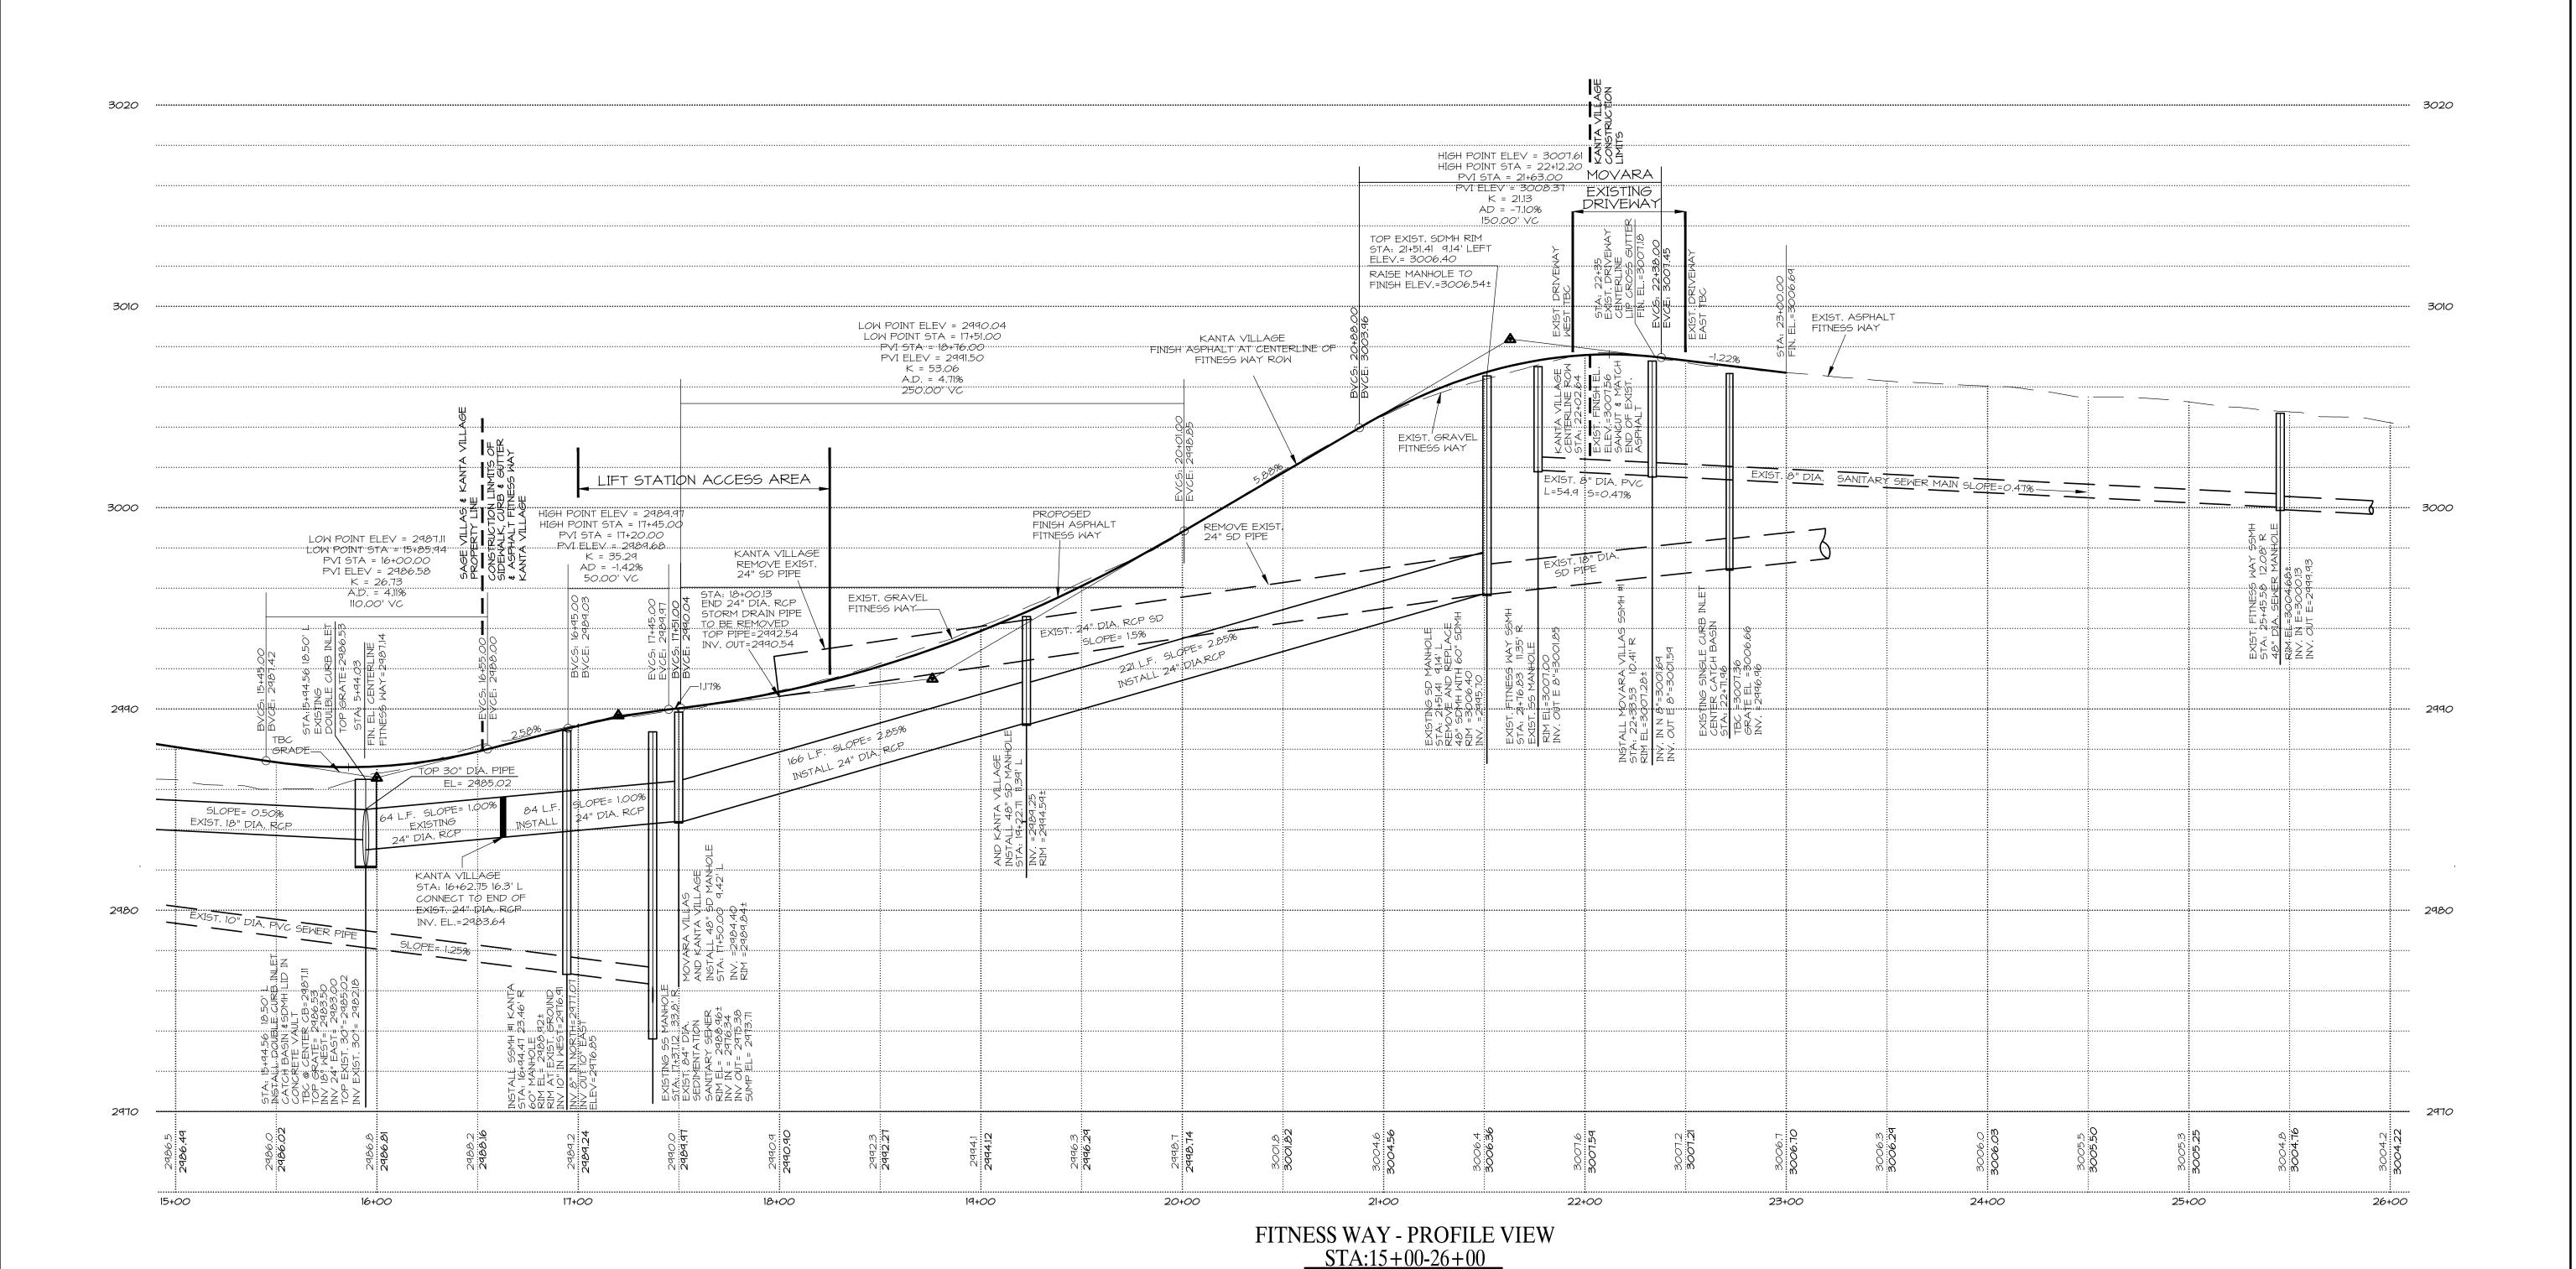
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FITNESS WAY NOTE: FOR FITNESS WAY PLAN REFER TO SHT. C4.0





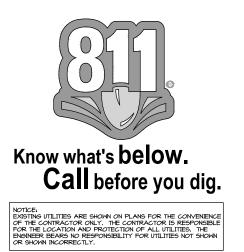

HORIZ. SCALE: 1"=40' VERT. SCALE: 1"=8' FERSIONS I

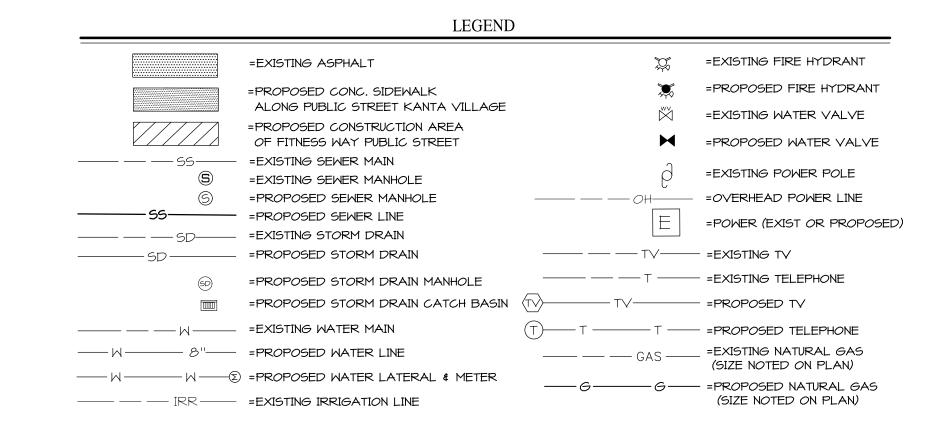JOB NO.:

DESIGNED BY:

CHECKED BY:

DWG: BM 5881 Master

5881-18-017

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PROFILE FITNESS WAY
FOR KANTA VILLAGE