




2 ATM ENLARGED PLAN  
SCALE: 1" = 10'

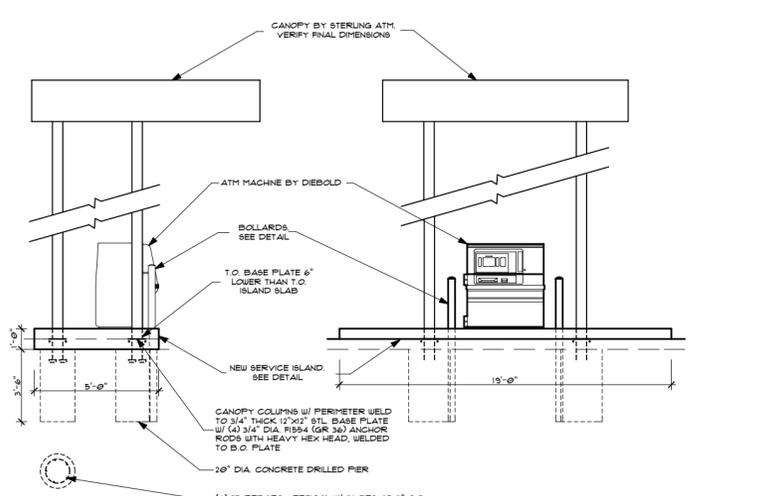

3 ATM ELEVATIONS  
SCALE: 1/4" = 1'-0"

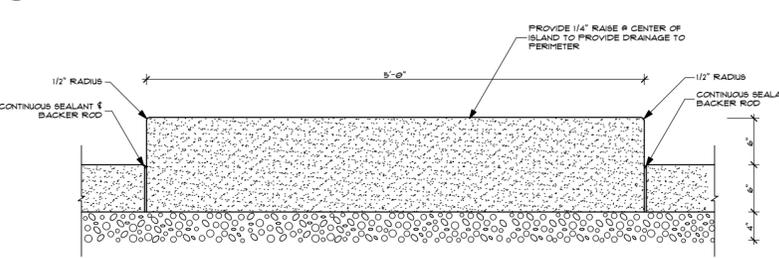


4 ISLAND DETAIL  
SCALE: 1" = 1'-0"

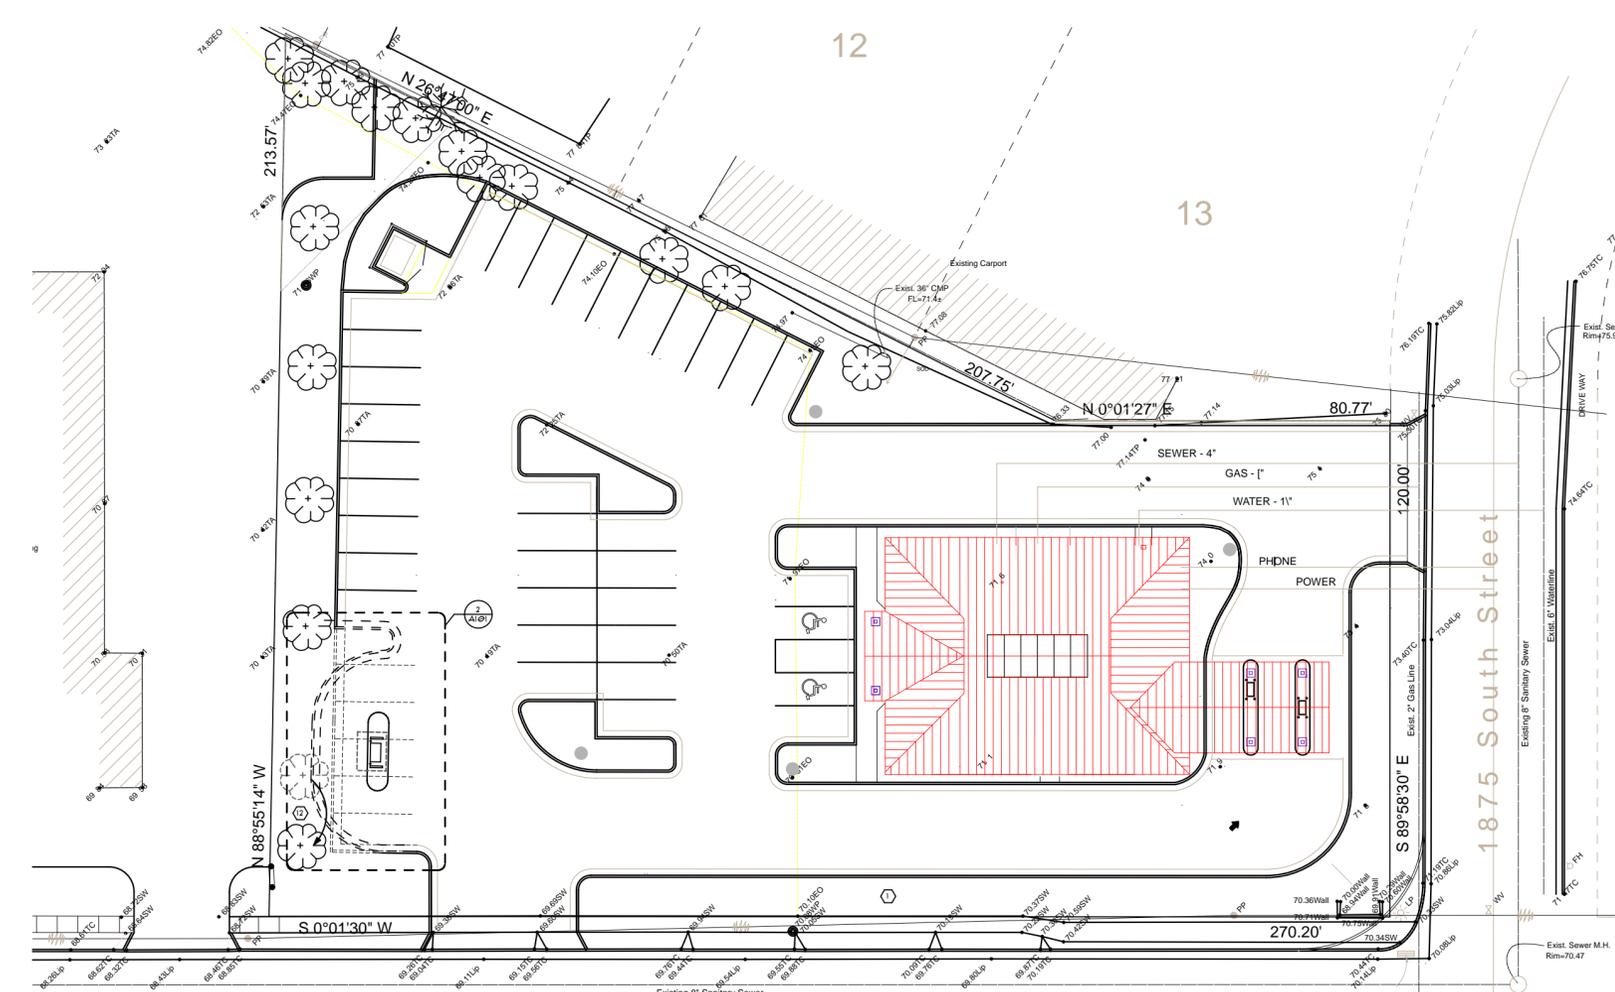


1 SITE PLAN  
SCALE: 1" = 20'

500 West Street  
U.S. Highway 91  
1875 South Street


PARKING REQUIREMENTS  
1 PARKING SPACE PER 200SF OF GROSS BUILDING AREA  
3,164SF / 200 = 15.82 REQUIRED SPACES  
35 SPACES PROVIDED (INCLUDING HDGP) > 15 SPACES REQUIRED

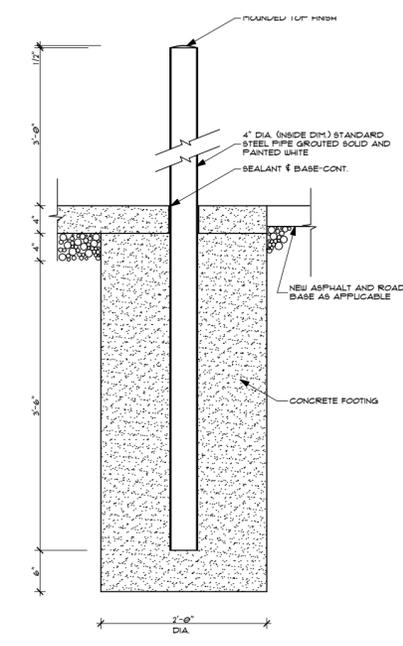


5 BOLLARD DETAIL  
SCALE: 1" = 1'-0"

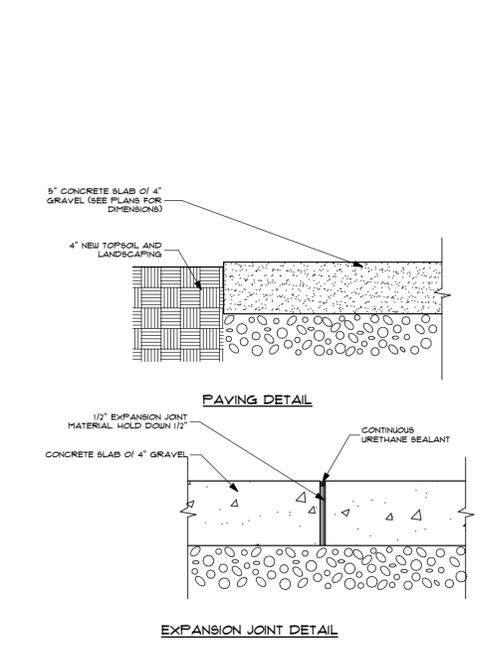

6 DETAILS  
SCALE: 1 1/2" = 1'-0"

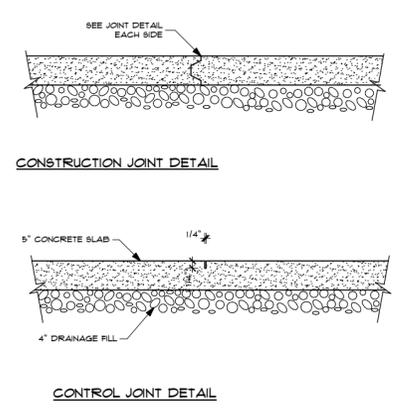

7 CURB DETAIL  
SCALE: 1" = 1'-0"

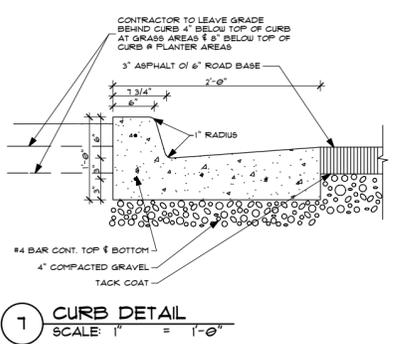

8 CURB DETAIL  
SCALE: 1" = 1'-0"

- KEYNOTES**
- PROVIDE NEW POLYMER/DATE CONDUIT TO EXISTING SIGN LOCATION. VERIFY SIZE WITH OWNER.
  - EXISTING CURB, GUTTER AND ASPHALT TO BE REMOVED.
  - NEW CURB & GUTTER, MATCH EXISTING.
  - BOLLARDS, SEE DETAIL.
  - CONCRETE ISLAND.
  - OVERHEAD CANOPY BY STERLING ATM. COORDINATE ELECTRICAL FOR CANOPY LIGHTS.
  - DIEBOLD ATM UNIT BY OTHERS (N.I.C.) COORDINATE PLACEMENT WITH OWNER PROVIDED INSTALLER.
  - NEW 2 1/2" ASPHALT PAVING ON 6" COMPACTED BASE.
  - NEW ELECT. LINE 110V WATERPROOF CONDUIT W/ LOW VOLTAGE DATA LINE IN SEPARATE CONDUIT. PATCH AND REPAIR SAUCUT TRENCH.
  - NEW TELEPHONE LINE IN WATERPROOF CONDUIT. PATCH AND REPAIR SAUCUT TRENCH.
  - NEW 6" CONC. SLAB ON 6" COMPACTED BASE.
  - RELOCATE EXISTING TREE.

**EMA**  
PLANNING • ARCHITECTURE • INTERIORS

PROJECT: MOUNTAIN AMERICA C.U. WOODS CROSS TI  
1843 S 500 W  
WOODS CROSS, UT 84081

PROJECT #FN: 1008 WASHINGTON BLVD. - GREEN UT 84061 | PH: 801-469-0741 | WWW.ESUBSERV.COM

ARCHITECTURAL SITE PLAN

SHEET NUMBER: A101

DO NOT SCALE DRAWING