


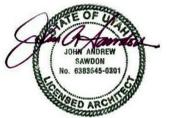

STAMP



CONSULTANT



UVU - PS INFILL  
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REVISIONS:

Rev	Date	Revision Description

ISSUE TYPE: 100% CONSTRUCTION DOCUMENTS

ISSUE DATE 12/05/14


DFCM PROJECT NO: --  
 DRAWN BY: ASV  
 CHECKED BY: MDP  
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 PROJECT NO: 140029

SHEET TITLE

FLOOR PLAN

SHEET NUMBER

AE101

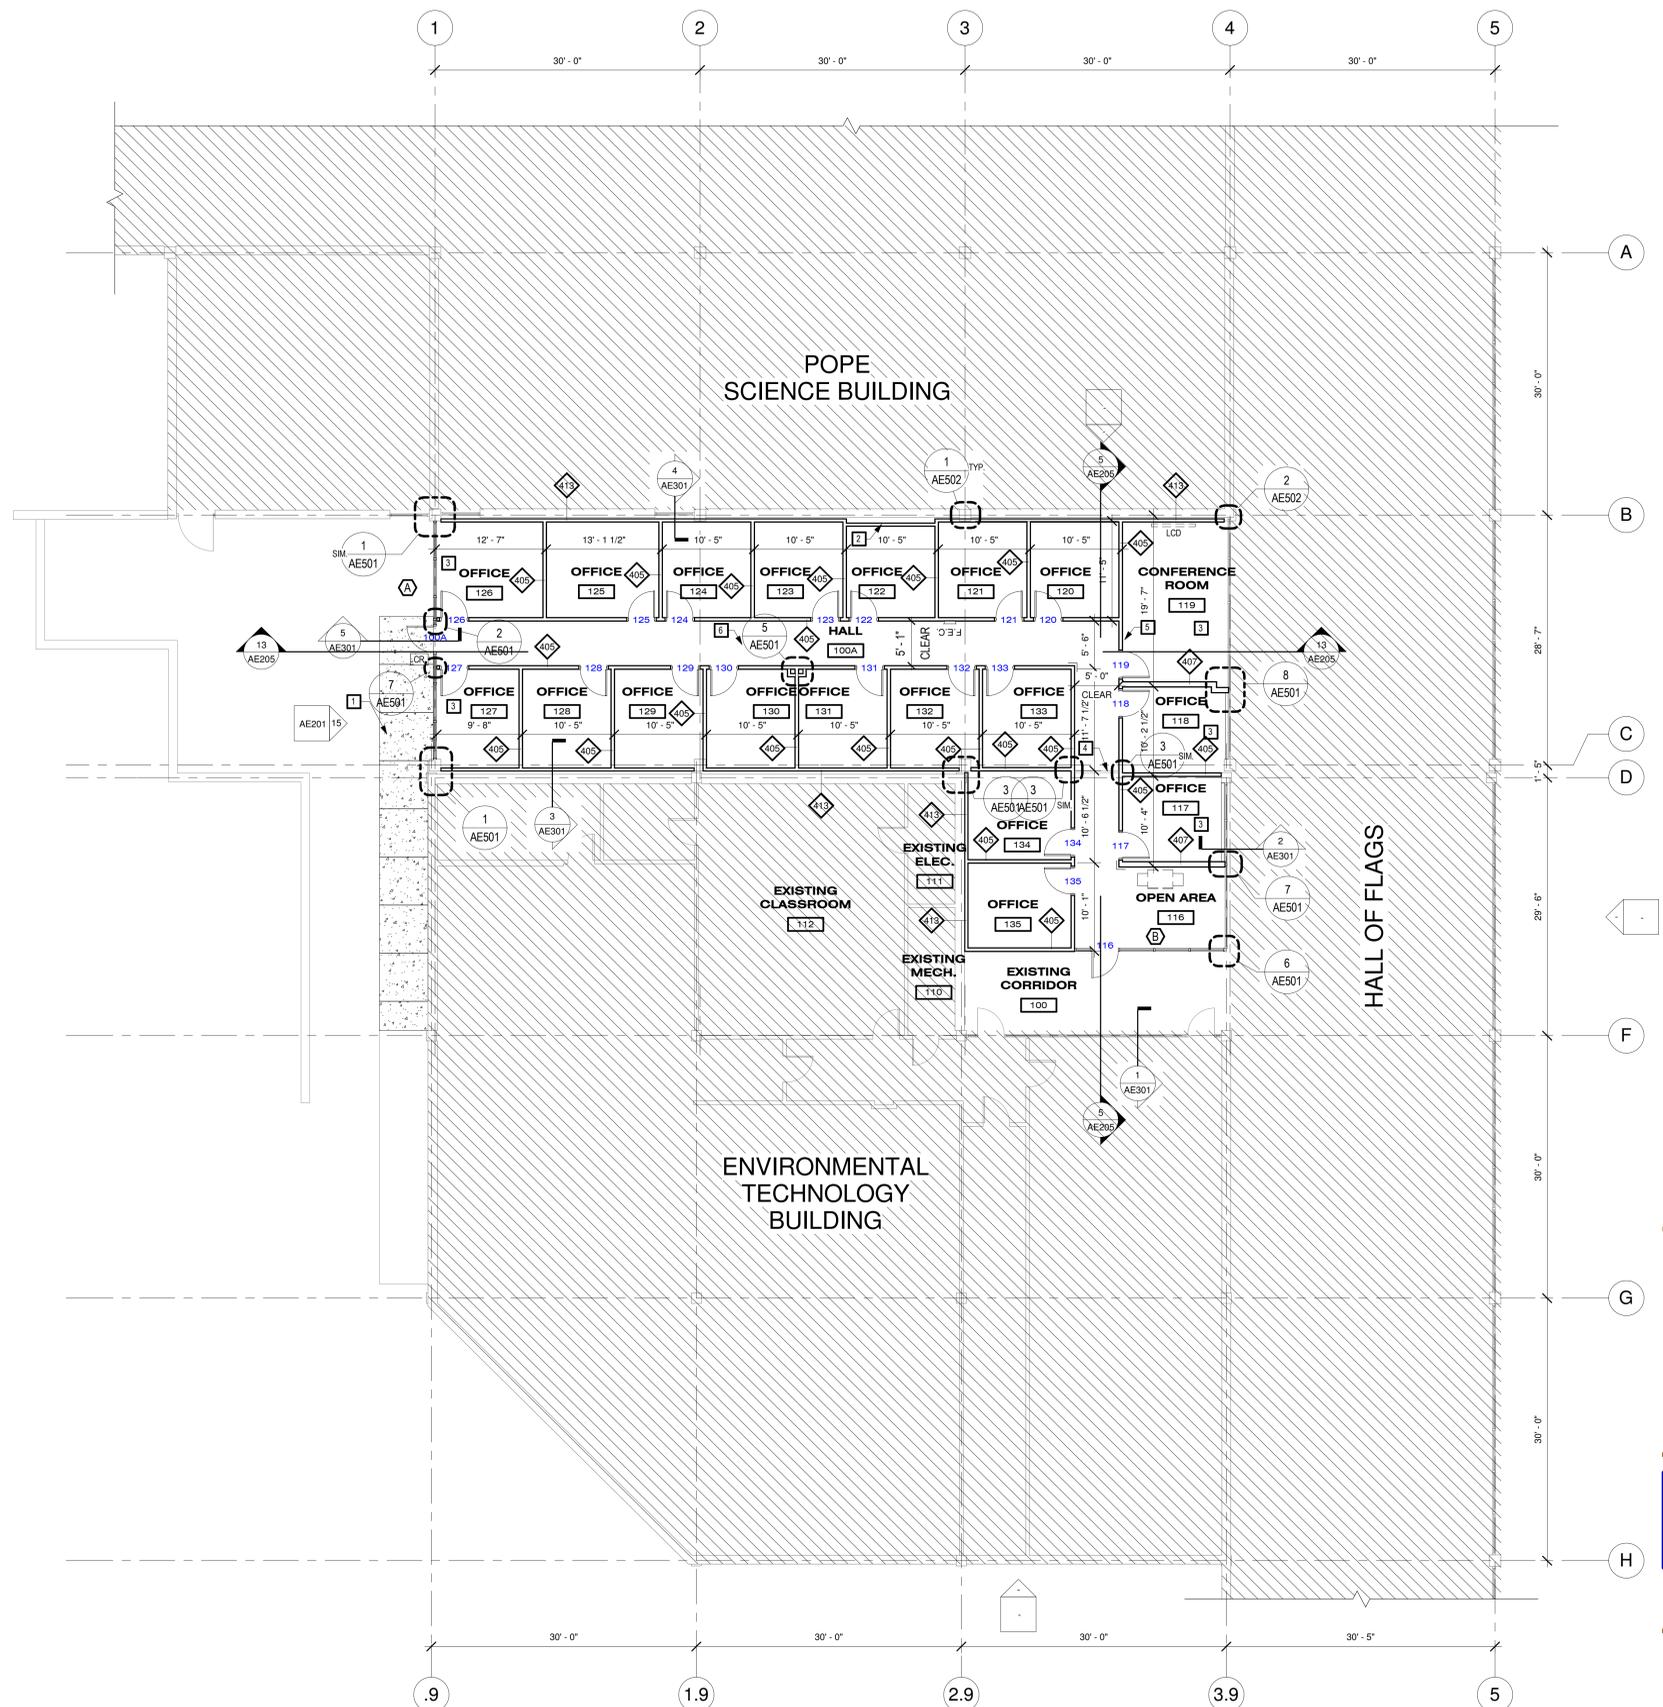

**SHEET NOTES**

- A. ALL DIMENSIONS ARE TO FACE OF STUDS OR CENTER LINE OF GRIDS UNLESS NOTED OTHERWISE. ALL CLEAR DIMENSIONS ARE FROM FACE OF FINISH CONDITIONS. INCLUDING BUT NOT LIMITED TO DIMENSIONS, UTILITY LOCATIONS AND UTILITY SIZES.
- B. CONTRACTOR SHALL PRIOR TO COMMENCEMENT OF WORK, FIELD VERIFY ALL EXISTING CONDITIONS. INCLUDING BUT NOT LIMITED TO DIMENSIONS, UTILITY LOCATIONS AND UTILITY SIZES.
- C. SHOULD ANY CONDITION ARISE WHERE THE INTENT OF DRAWINGS ARE IN DOUBT, OR THERE IS A DISCREPANCY BETWEEN DRAWINGS AND FIELD CONDITIONS, THE CONTRACTOR SHALL NOTIFY THE ARCHITECT IN WRITING FOR CLARIFICATION. RECORD ANY DISCREPANCY ON A REPRODUCIBLE DOCUMENT AND TRANSMIT TO THE ARCHITECT FOR PROJECT RECORD, COORDINATION AND NECESSARY RESOLUTION PRIOR TO CONTINUING WORK.
- D. WRITTEN DIMENSIONS TAKE PRECEDENCE OVER SCALED SIZES. DO NOT SCALE DRAWINGS TO DETERMINE ANY LOCATIONS. ARCHITECT SHALL BE NOTIFIED OF ANY DISCREPANCIES PRIOR TO CONTINUING THE WORK.
- E. CONSULTANT ENGINEERING DRAWINGS ARE SUPPLEMENTARY TO THE ARCHITECTURAL DRAWINGS. THE CONTRACTOR SHALL BE RESPONSIBLE TO REVIEW THE ARCHITECTURAL DRAWINGS PRIOR TO THE INSTALLATION OF ANY WORK SHOWN ON THE CONSULTANT ENGINEER'S DRAWINGS. ANY DISCREPANCY BETWEEN ARCHITECTURAL AND CONSULTANT ENGINEER'S DRAWINGS SHALL BE BROUGHT TO THE ATTENTION OF THE ARCHITECT FOR CLARIFICATION AND RESOLUTION PRIOR TO COMMENCING WORK.
- F. DIMENSIONS AND EXISTING ITEMS LOCATION IS BASED UPON INFORMATION PRIOR BY OTHERS. THE ARCHITECT AND CONSULTANT ENGINEER ASSUMES NO RESPONSIBILITY FOR THE ACCURACY.
- G. ALL EXPOSED COLUMNS TO BE PAINTED.
- H. WHERE PRIMARY AND SECONDARY ROOF DRAINS DAYLIGHT, PROVIDE GRAVEL AT DISCHARGE POINT, COORDINATE LOCATION WITH MECHANICAL.

**KEY NOTES**

- 1 NEW 4" CONCRETE SIDEWALK OVER 4" GRANULAR BASE, FINISH TO MATCH EXISTING SIDEWALK. PROVIDE 1/8" CROSS SLOPE.
- 2 COORDINATE FINAL WALL LOCATION WITH RE-ROUTING OF EXISTING OVERFLOW DRAIN, SEE MECHANICAL.
- 3 PROVIDE NEW HORIZONTAL LOUVER BLINDS FOR FULL HEIGHT OF ENTIRE WINDOW SYSTEM.
- 4 FLOOR EXPANSION JOINT, SEE 16/AE501
- 5 DIMMING CONTROL PAD, SEE ELECTRICAL
- 6 EXISTING WASTE CLEANOUT

**FLOOR PLAN LEGEND**

- LCD, BY OTHERS
- OR CARD READER
- F.E.C. FIRE EXTINGUISHER & CABINET
- STAINLESS STEEL CORNER GUARD, SEE SPECS
- COPIER, N.I.C

**WALL LEGEND**

SYMBOL	WALL DESCRIPTION	RATING
---	EXISTING WALL	--
---	3 5/8" METAL STUD	N/R
---	SEE WALL SCHEDULE ON THIS SHEET FOR WALL TYPES	

**WALL SCHEDULE**

WALL #	DESCRIPTION	FIRE INFORMATION		WALL TERMINATION DETAIL		STO RATING	R VALUE
		FIRE RATING	FIRE TEST	TYPE	HEAD SILL		
405	3 5/8" METAL STUD	0HR	N/A	5/8" GP	5/8" GP	ABOVE CEILING	--
407	6" METAL STUD	0HR	N/A	5/8" GP	5/8" GP	ABOVE CEILING	--
413	3 5/8" METAL STUD	0HR	N/A	5/8" GP	5/8" GP	ABOVE CEILING	--

**WALL SCHEDULE NOTES**

- 1. ALL METAL STUD WALL FRAMING SHALL COMPLY WITH ASTM C645 OR C754. STUD SIZES LISTED ARE MINIMUMS. COMPLY WITH MANUFACTURERS LISTING FOR MAXIMUM HEIGHT LIMITATIONS, STUD SIZES, SPACING, GAUGE AND BRIDGING REQUIREMENTS. SEE SHEET AE505 FOR TYPICAL METAL STUD FRAMING.
  - 2. WHERE WALLS OF VARIOUS THICKNESSES MEET OR WHERE NEW WORK ADJOINS EXISTING CONSTRUCTION, A FLUSH SURFACE SHALL BE PROVIDED ON THE SIDE WHERE FACES ARE STRAIGHT AND CONTINUOUS.
- ABBREVIATIONS  
 GP - GYPSUM PAPER

**FLOOR PLAN** (FINISH FLOOR ELEVATION = 100'-0")

1/8" = 1'-0"

