

CODE SUMMARY

APPLICABLE CODE:
2015 INTERNATIONAL RESIDENTIAL CODE (I.R.C.)
2015 INTERNATIONAL MECHANICAL CODE
2015 INTERNATIONAL PLUMBING CODE
2017 NATIONAL ELECTRICAL CODE

BUILDING AREAS:
BASEMENT AREA 1713 SQ.FT.
MAIN FLOOR AREA 1705 SQ.FT.
UPPER FLOOR AREA 0 SQ.FT.
GARAGE AREA 909 SQ.FT.
FRONT PORCH AREA 65 SQ.FT.
REAR PATIO AREA 183 SQ.FT.

SEE STRUCTURAL CALCULATIONS FOR STRUCTURAL DESIGN CRITERIA.
OCCUPANCY: RESIDENTIAL

PROJECT LOCATION: LOT: #170-

LOT: #170-D
SUBDIVISION: Toquerville
ADDRESS: 305 W. Shangri-La
CITY: Toquerville, UT 84774

SHEET INDEX

GENERAL DRAWINGS

A0.1 - COVER SHEET SITE PLAN

ARCHITECTURAL DRAWINGS

A1.1 - FTG & FOUNDATION PLAN A1.2 - BASEMENT FLOOR PLAN A1.3 - MAIN FLOOR PLAN

A1.3 - MAIN FLOOR PI A1.4 - ROOF PLAN A2.1 - ELEVATIONS

A3.1 - BUILDING SECTIONS

ELECTRICAL DRAWINGS

E1.1 - ELECTRICAL PLANS

PROJECT INFORMATION

THESE DRAWINGS ARE PART OF A SET OF CONSTRUCTION DOCUMENTS.
THE CONSTRUCTION DOCUMENTS CONSIST OF ONE OR MORE OF
THE FOLLOWING ELEMENTS:

• CONSTRUCTION DRAWINGS

• SPECIFICATIONS

STRUCTURAL CALCULATIONS
 CONTRACT FORMS

CONTRACT FORMS & CONDITIONSMODIFICATIONS & REVISIONS

CONTRACTORS, SUBCONTRACTORS, AND OTHERS WHO PROVIDE LABOR AND/OR MATERIALS REFERENCING THESE DRAWINGS ARE RESPONSIBLE FOR OBTAINING AND REVIEWING ALL CURRENT CONSTRUCTION DOCUMENTS.

CONTRACTORS, SUBCONTRACTORS, AND OTHERS ARE TO REPORT ANY DISCREPANCIES OR ERRORS TO J. LONNIE FOX DRAFTING AND DESIGN IMMEDIATELY. ANY CHANGES TO THE PROJECT WILL BE VERIFIED WITH THE OWNER AND/OR BUILDER AND REVISIONS MADE. CONTRACTORS ARE NOT TO MAKE ALTERATIONS OF ANY KIND WITHOUT PRIOR WRITTEN CONSENT. DISCREPANCIES NOT REPORTED IMMEDIATELY ARE RESPONSIBILITY OF CONTRACTOR.

CONTRACTORS SHALL NOT SCALE FROM DRAWINGS. DIMENSIONS ARE PROVIDED TO ALLOW FOR ACCURATE CONSTRUCTION OF BUILDING. QUESTIONS ARISING FROM DIMENSIONS SHOULD BE RESOLVED BY CONTACTING ARCHITECT/DRAFTSMAN.

CONSULTANTS

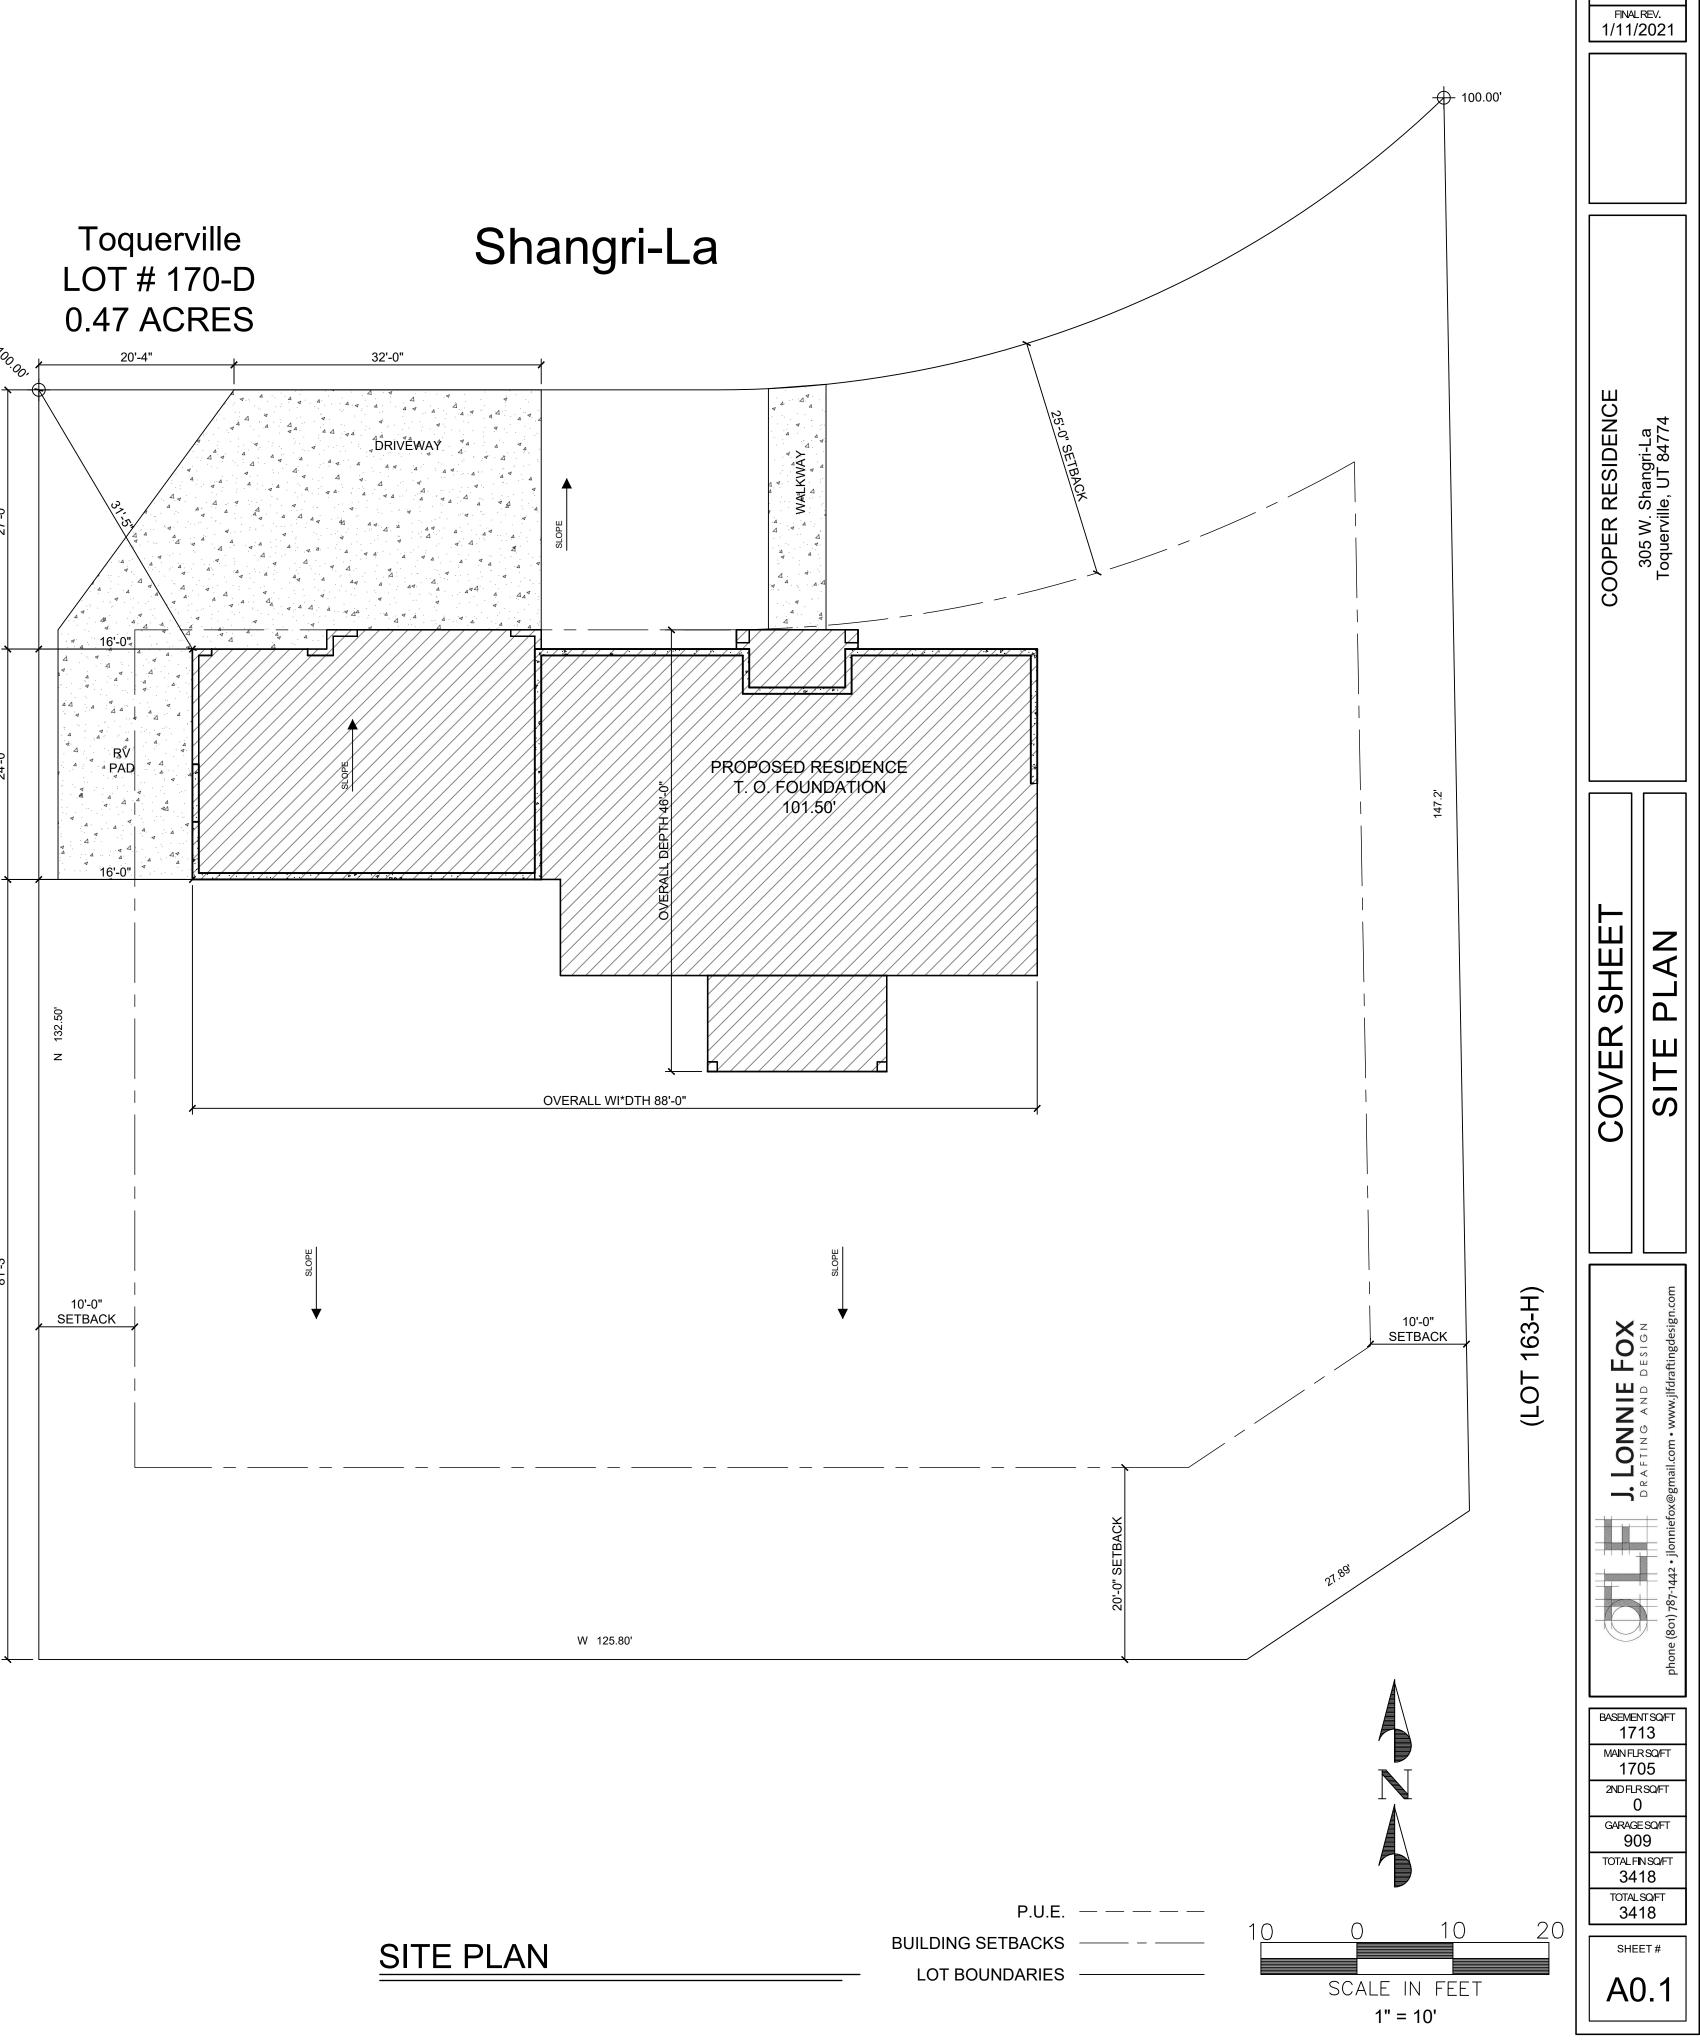
STRUCTURAL ENGINEER

ACUTE ENGINEERING 344 SUNLAND DR., #2B ST. GEORGE, UT 84790 TEL (801) 229 - 9020 FAX (801) 224-0050

GENERAL CONTRACTOR

CONTRACTOR

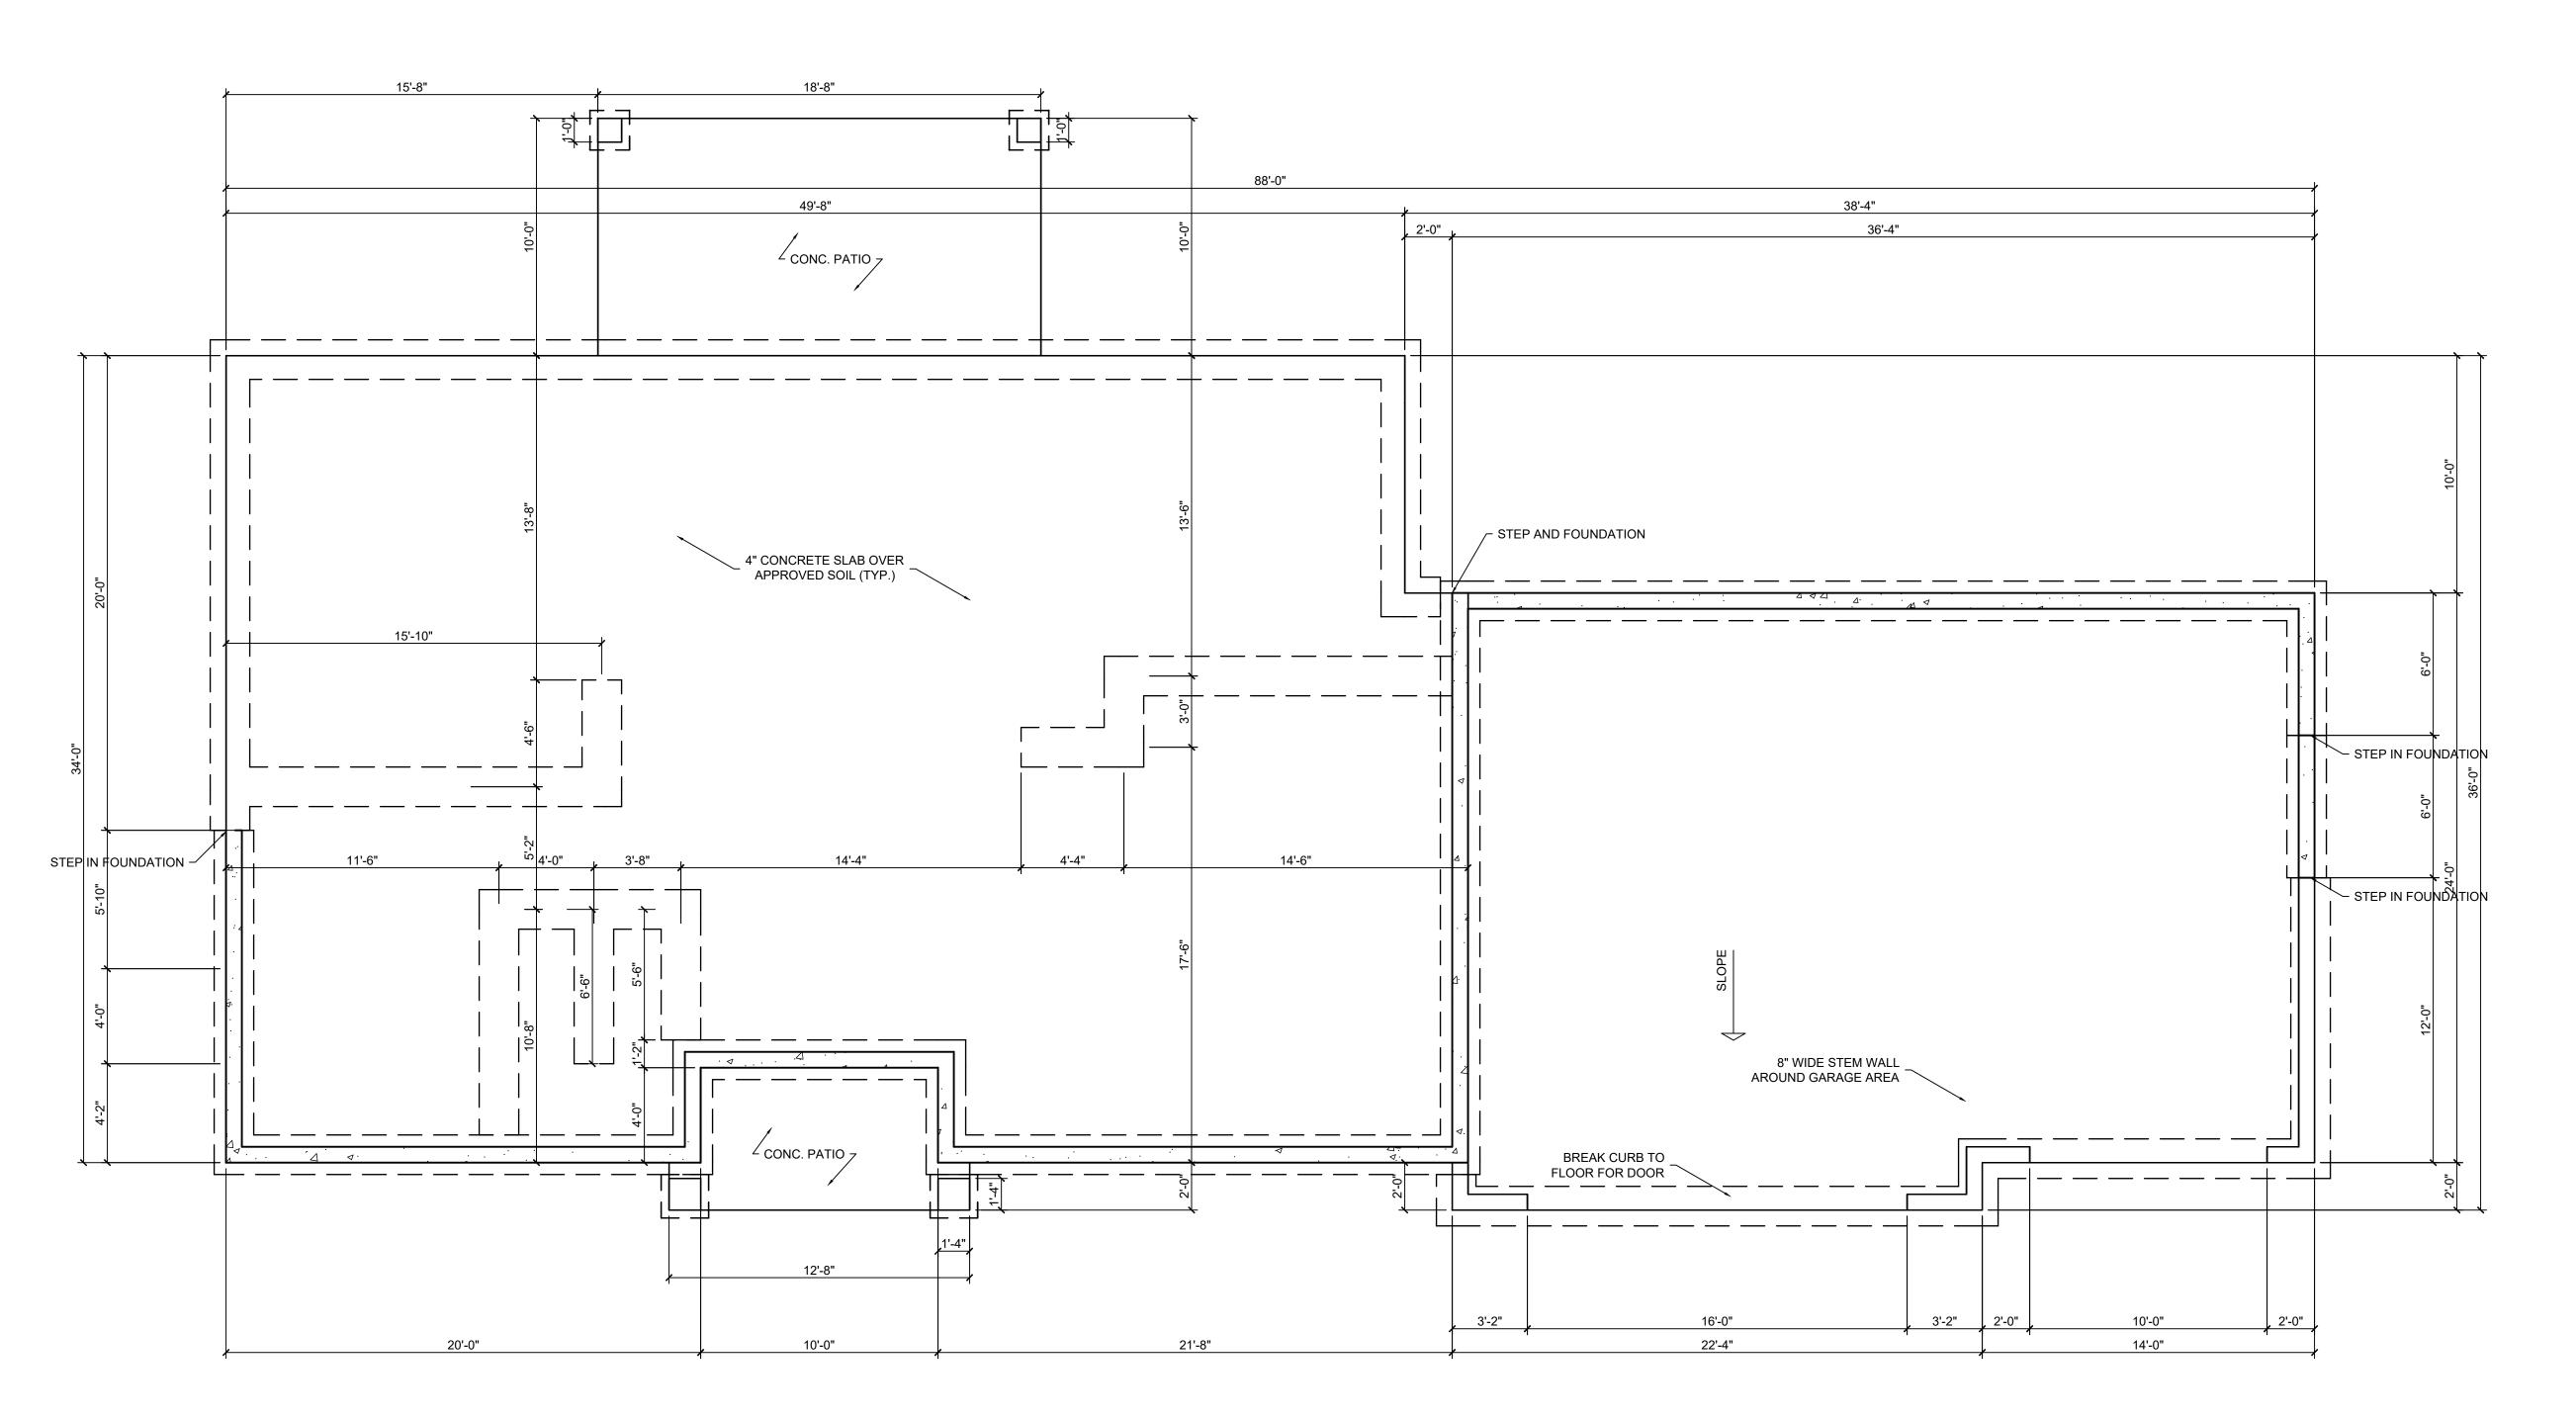
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20-142

GENERAL BASEMENT NOTES:

- 1" WATER LINE REQUIRED TO ALL WATER HEATERS.
 WATER HEATERS TO HAVE ENGINEERED SEISMIC CONNECTION STRAPS.
 COMBUSTION AIR MUST ENTER FROM EXTERIOR OF MECHANICAL ROOM.
- ALL CONCRETE BELOW FINAL GRADE MUST HAVE DAMP PROOFING.
 1 EGRESS LANDER REQUIRED IF NO OTHER EXIT.



JLF PROJECT# 20-142 REV.1 REV.2 FINAL REV. 1/11/2021 TION PLAN

TOTALFINSO/FT 3418

SHEET# A1.1

MECHANICAL:

- 1. COMBUSTION AIR TO BE TAKEN FROM OUTSIDE
- 2. COMBUSTION AIR DUCTS TO BE LOCATED WITHIN THE UPPER 12" OF CEILING AND WITHIN
- 3. DUCTS USED FOR COMBUSTION TO REMAIN SEPARATE FROM THE ENCLOSURE TO THE
- 4. FURNACE IN A CLOSET SHALL HAVE A MIN. 3" CLEAR WORKING SURFACE ON SIDES &
- 5. THENCE SHALL TERMINATE 4' BELOW OR 4' HORIZONTALLY & AT LEAST ONE' ABOVE A
- DOOR, OPERABLE WINDOW OR GRAVITY AIR INLET INTO A BUILDING.
- 6. FLUE & EXHAUST FAN VENTS SHALL BE AT LEAST 3' ABOVE & OUTSIDE AIR INLET LOCATED WITHIN 10' & AT LEAST 4' FROM PROPERTY LINE.
- VENT CLOSE DRYER TO OUTSIDE. DUCTS TO BE METAL WITH SMOOTH INTERIOR SURFACES, EQUIPPED WITH BACK DRAFT DAMPERS TERMINATE AT THE EXTERIOR OF THE BUILDING AND NOT TO BE INSTALLED WITH SHEET METAL SCREWS. MINIMUM DUCT
- 8. MIN. 30" CLEARANCE REQ'D ABOVE RANGE TOP TO COMBUSTIBLES.
- COOKTOPS & MICROWAVES INSTALLED ABOVE COOKTOPS SHALL CONFORM TO THE CONDITIONS OF THEIR LISTINGS.
- 10. BATHROOMS & LAUNDRY ROOMS WITHOUT AN OPENABLE WINDOW ARE REQ'D TO HAVE
- EXHAUST FANS PROVIDING 5 AIR CHANGES PER HOUR. 11. PROVIDE COMBUSTION AIR TO LAUNDRY AREA.

THERMAL ENVELOPE:

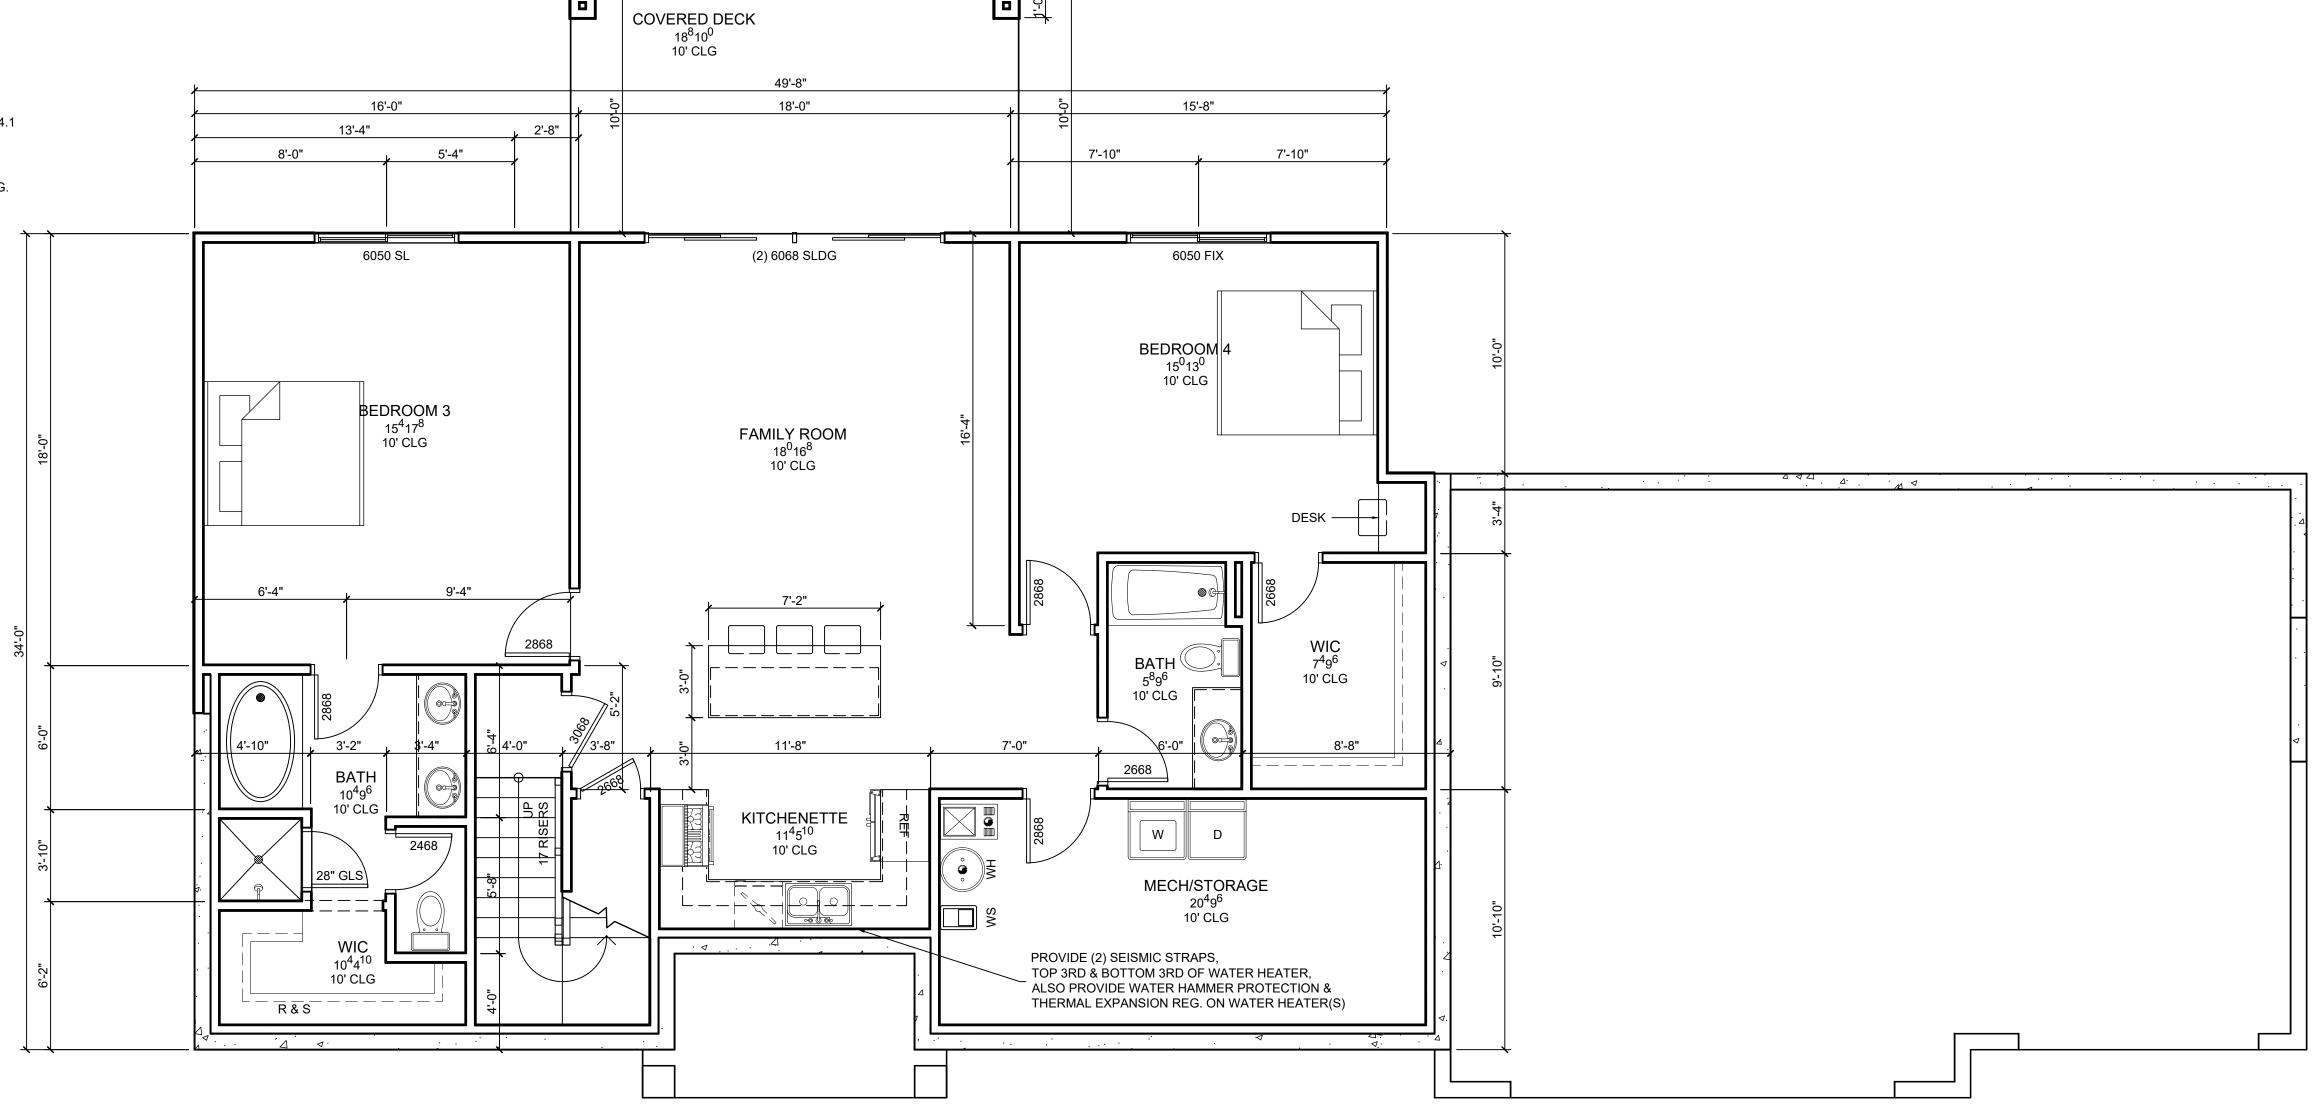
- 1. BUILDING THERMAL ENVELOPE IS REQUIRED TO BE SEALED. (2012 IRC SECTION N1102.4.1 AND TABLE N1102.4.1.1)
- 2. ALL AIR LEAKAGE REQUIREMENTS OF TABLE 402.4.1.1 MUST BE MET AND TESTING OF DUCTS & BLOWER WILL BE REQUIRED.
- BLOWER DOOR OR DUCT TESTING WILL REQUIRE AN INSPECTION TO WITNESS TESTING.
- 4. SEE SECTIONS & DETAILS FOR INSULATION R-VALUES
- 5. ALL DUCTS, AIR HANDLERS, FILTER BOXES, AND BUILDING CAVITIES USED AS DUCTS SHALL BE SEALED. (2012 IRC SECTION N1103.2.2).

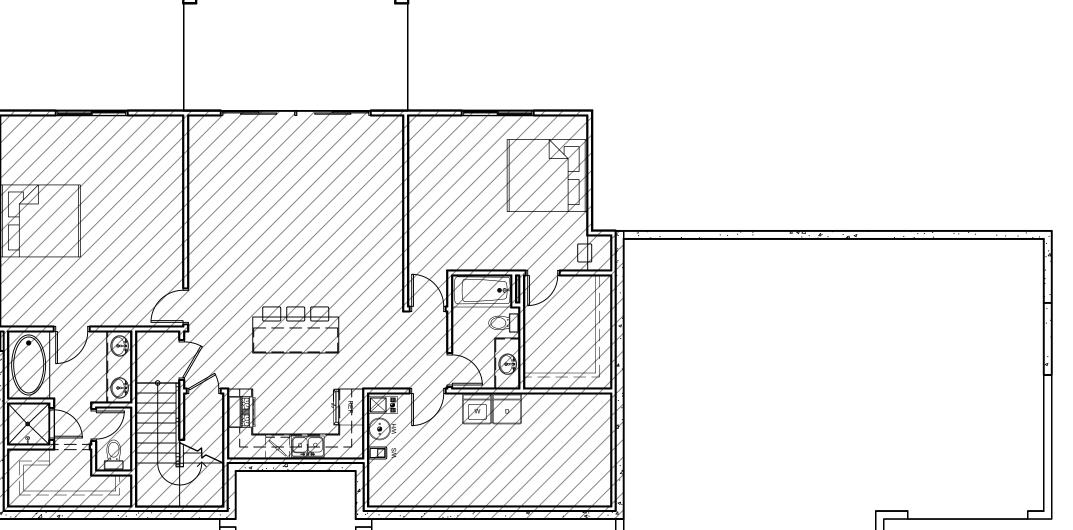
GENERAL BASEMENT NOTES:

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- 3. COMBUSTION AIR MUST ENTER FROM EXTERIOR OF MECHANICAL ROOM. 4. ALL CONCRETE BELOW FINAL GRADE MUST HAVE DAMP PROOFING.
- 5. 1 EGRESS LANDER REQUIRED IF NO OTHER EXIT.





BASEMENT CONDITIONED:14,157 FT.³

SCALE: NTS

BASEMENT FLOOR PLAN

JLF PROJECT# 20-142 REV.1 REV.2 FINAL REV. 1/11/2021 BASEMENT FL

SHEET#

MECHANICAL: 12" OF THE FLOOR. DOOR, OPERABLE WINDOW OR GRAVITY AIR INLET INTO A BUILDING. CONDITIONS OF THEIR LISTINGS. EXHAUST FANS PROVIDING 5 AIR CHANGES PER HOUR. AND TABLE N1102.4.1.1)

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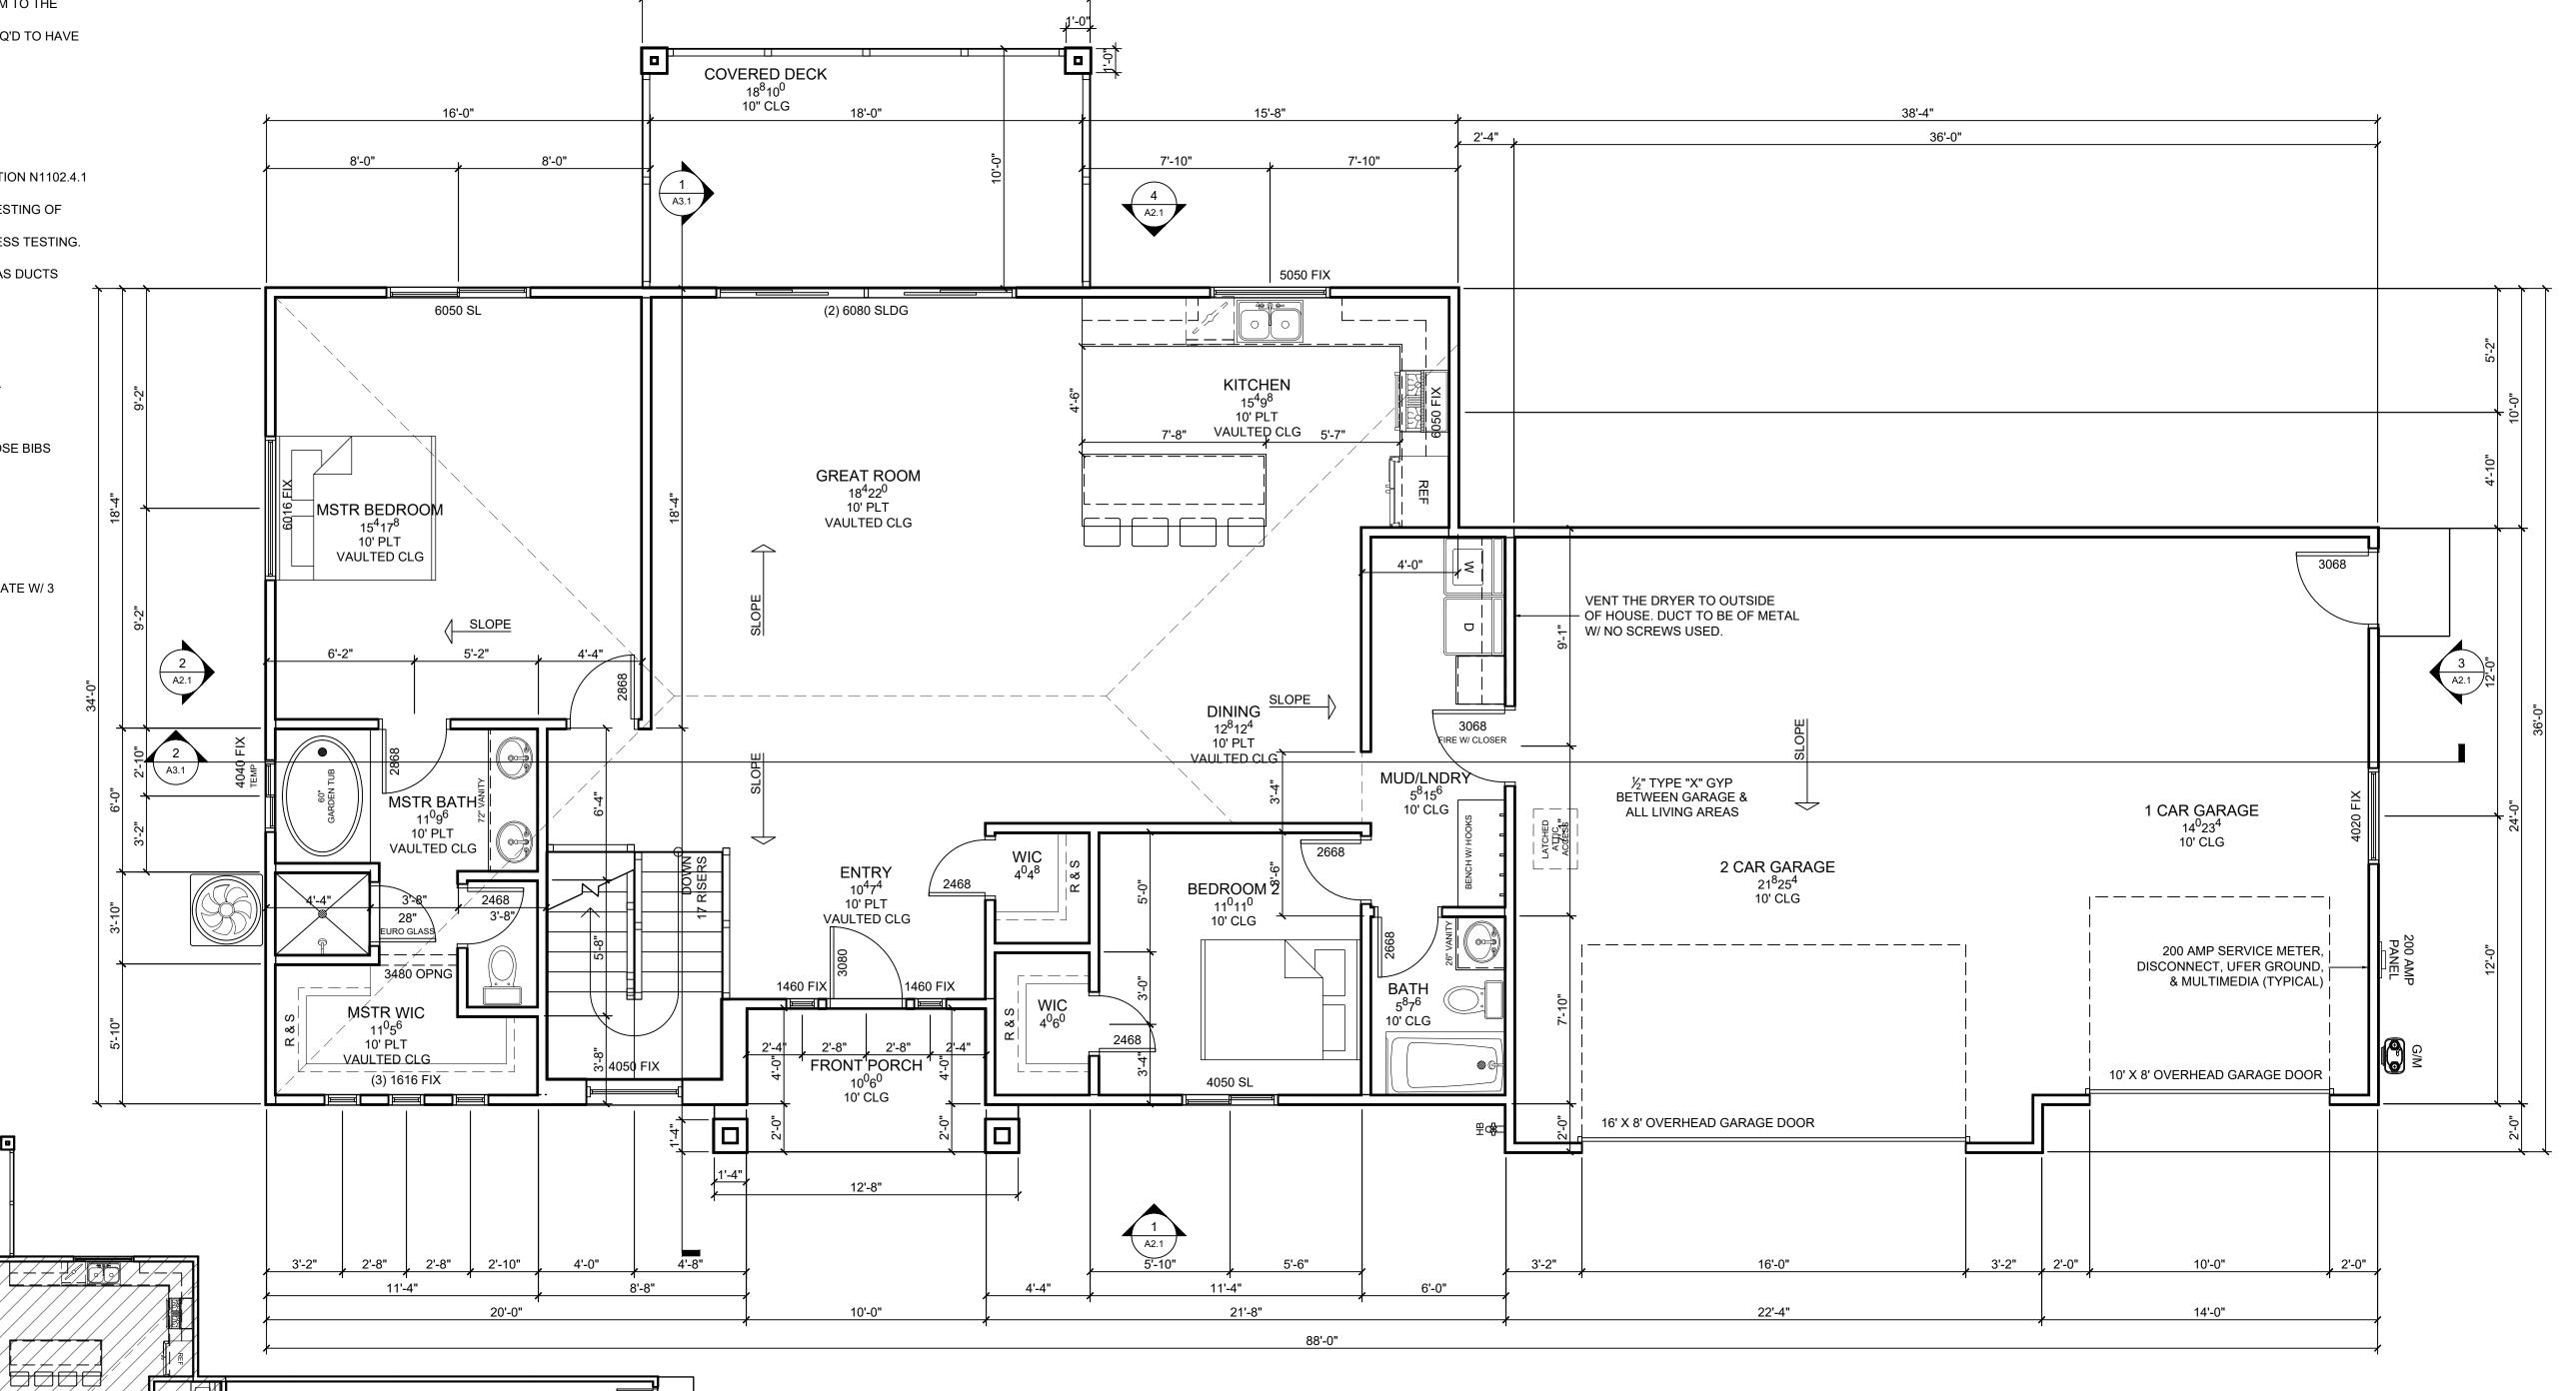
FLOOR LAYOUT GEN. NOTES:

- 1. 5/8" TYPE X GYPSUM BOARD ON CEILING OF GARAGE W/LIVING SPACE ABOVE.
- 2. ATTIC ACCESS REQUIRED. 3. VENT CLOTHES DRYER TO EXTERIOR.
- 4. FIREPLACE MUST BE ICC APPROVED.
- 5. STRUCTURE REQUIRED TO **HAVE** FREESLESS & BACKFLOW PREVENTED HOSE BIBS

STAIR NOTES:

IN BOTH FRONT AND REAR.

- 1. 6'-8" MINIMUM HEADROOM REQUIRED.
- 2. HANDRAIL REQUIRES 1½"-25/8" RETURN TO WALL OR NEWELL POST. 3. BASEMENT STAIR STRINGERS TO REST FULLY ON REDWOOD OR TREATED PLATE W/ 3 ANCHORS MINIMUM



MAIN FLOOR CONDITIONED:14,085 FT.³

SCALE: NTS

MAIN FLOOR PLAN

2X4 INTERIOR WALLS U.N.O.

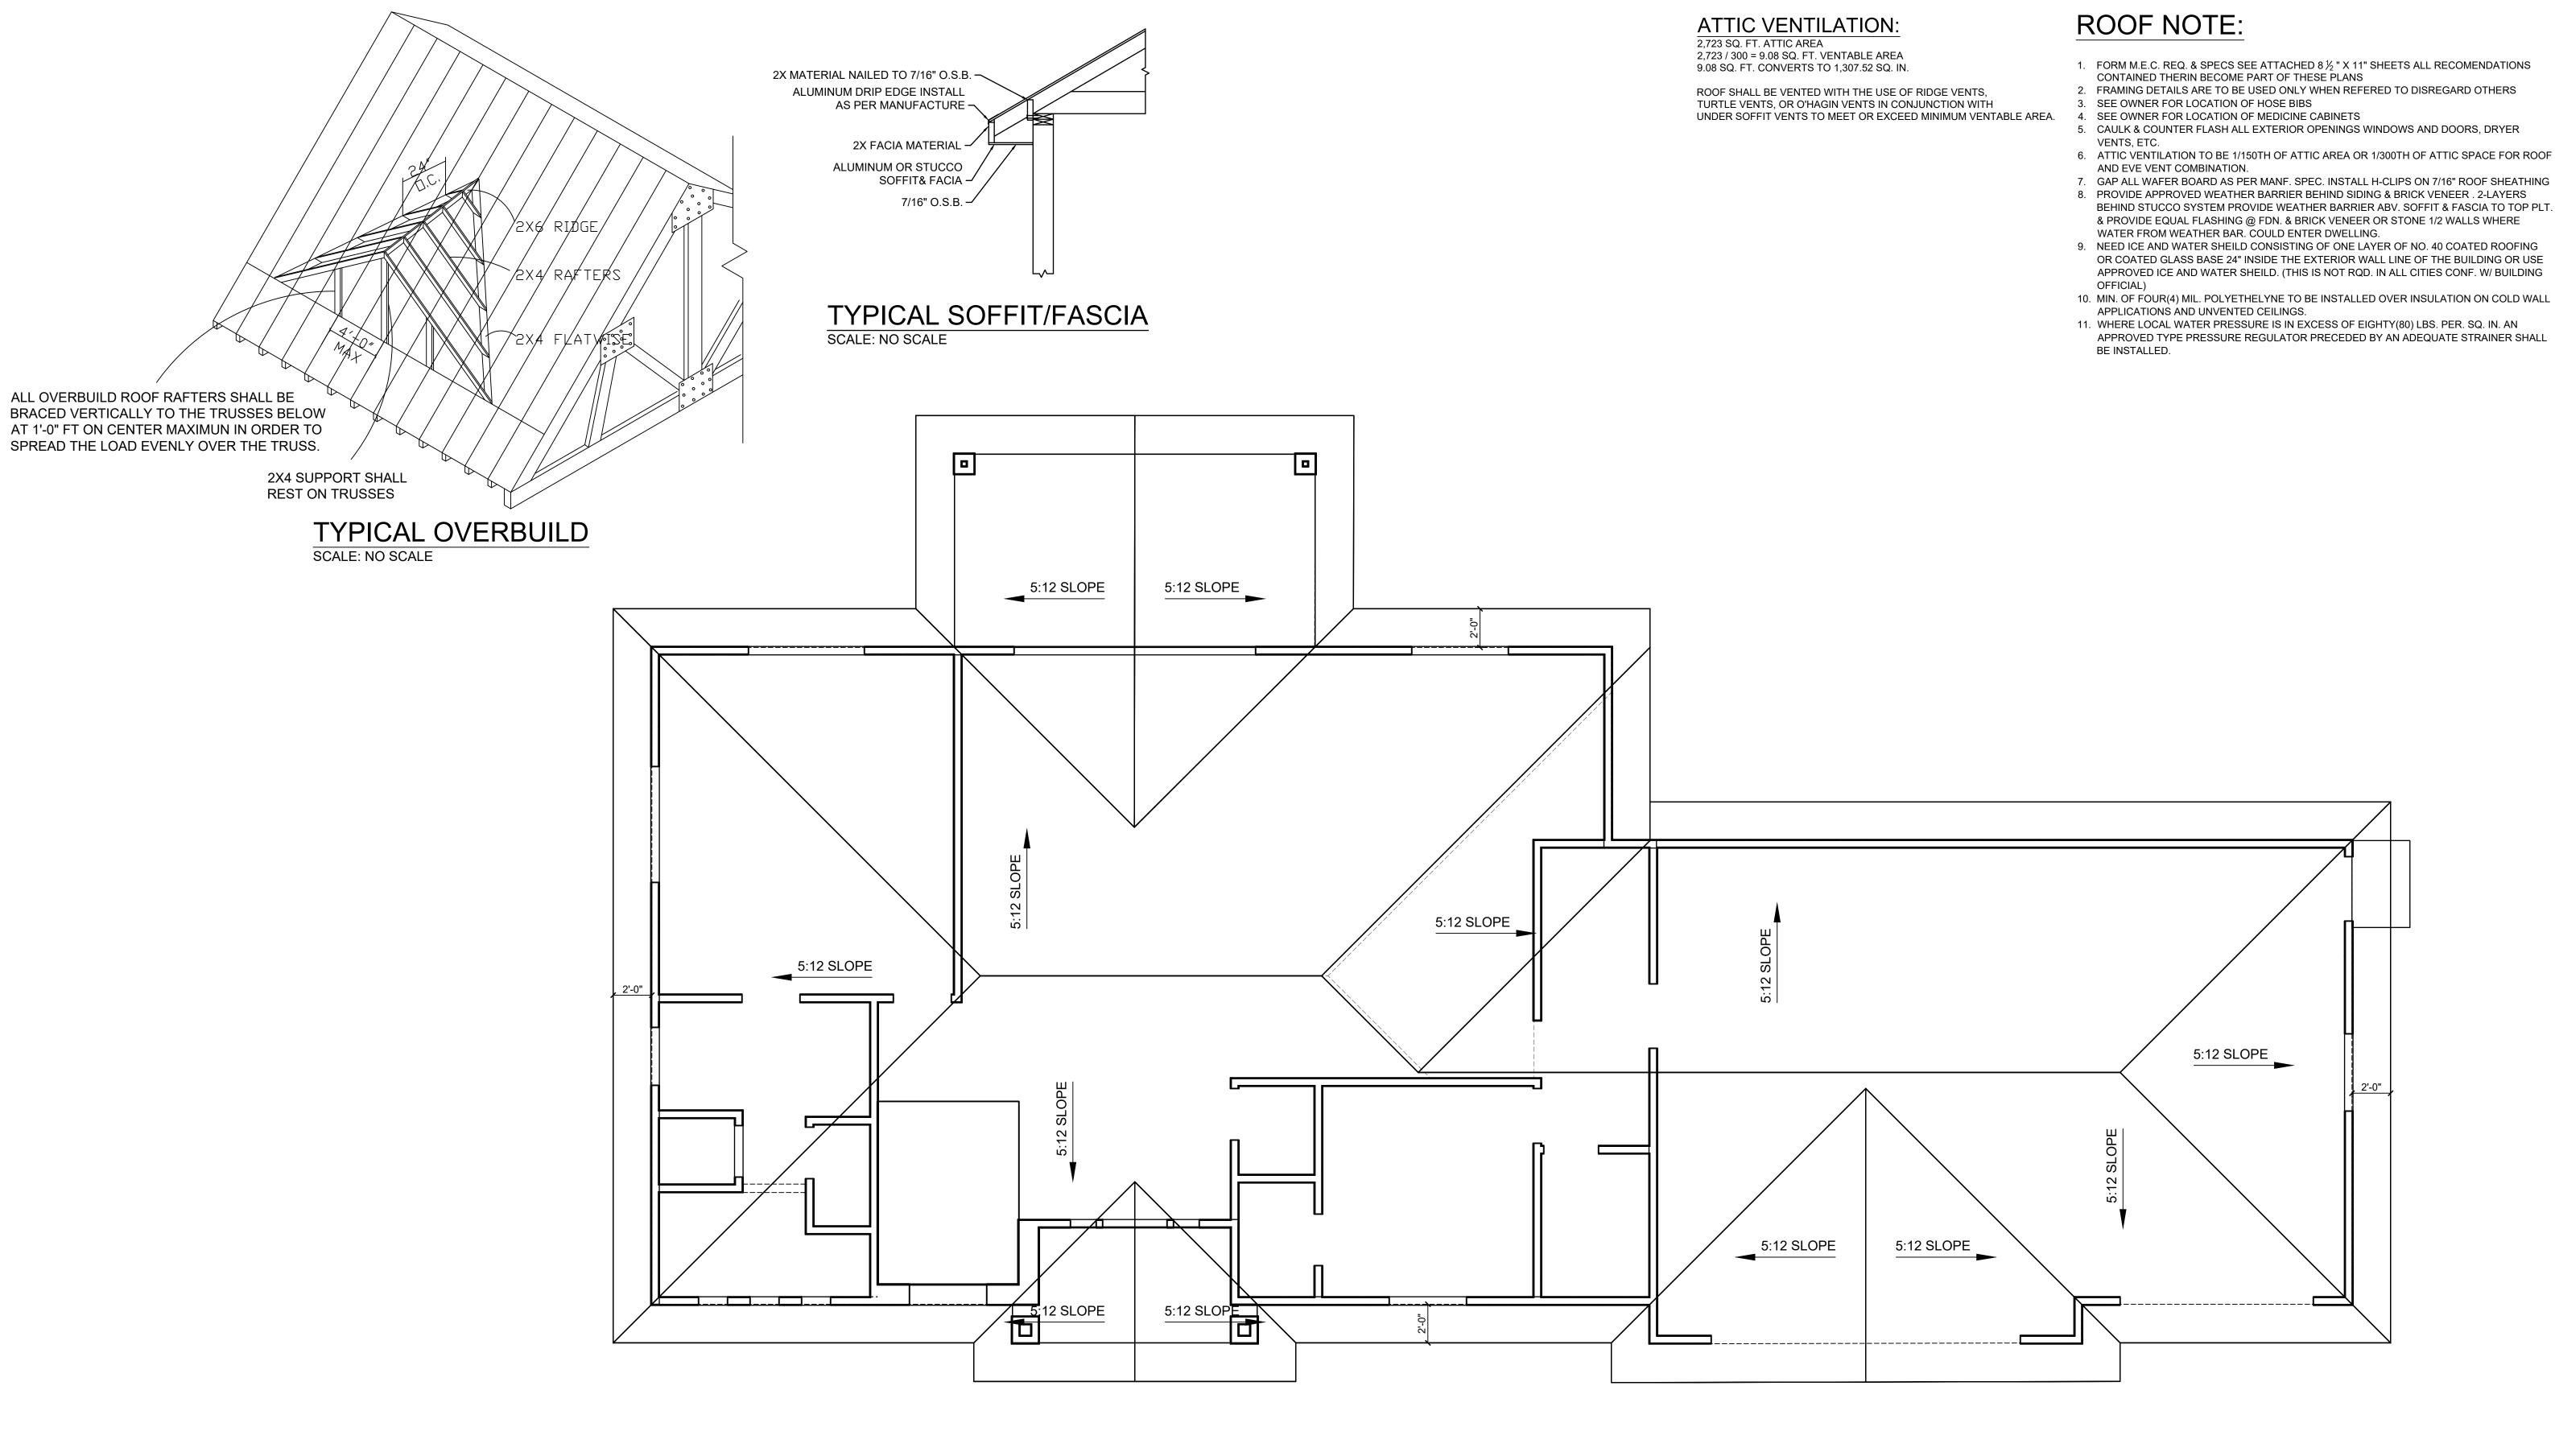
2X6 EXTERIOR WALLS U.N.O.

SCALE: 1/4" = 1'-0"

REV.1 REV.2 FINAL REV. 1/11/2021 $\mathbf{\alpha}$ 2NDFLRSQ/FT TOTAL FIN SQ/FT 3418 3418 SHEET# A1.3

JLF PROJECT#

20-142



1. FORM M.E.C. REQ. & SPECS SEE ATTACHED 8 ½ " X 11" SHEETS ALL RECOMENDATIONS

2. FRAMING DETAILS ARE TO BE USED ONLY WHEN REFERED TO DISREGARD OTHERS

5. CAULK & COUNTER FLASH ALL EXTERIOR OPENINGS WINDOWS AND DOORS, DRYER

6. ATTIC VENTILATION TO BE 1/150TH OF ATTIC AREA OR 1/300TH OF ATTIC SPACE FOR ROOF

8. PROVIDE APPROVED WEATHER BARRIER BEHIND SIDING & BRICK VENEER . 2-LAYERS BEHIND STUCCO SYSTEM PROVIDE WEATHER BARRIER ABV. SOFFIT & FASCIA TO TOP PLT.

9. NEED ICE AND WATER SHEILD CONSISTING OF ONE LAYER OF NO. 40 COATED ROOFING OR COATED GLASS BASE 24" INSIDE THE EXTERIOR WALL LINE OF THE BUILDING OR USE APPROVED ICE AND WATER SHEILD. (THIS IS NOT RQD. IN ALL CITIES CONF. W/ BUILDING

11. WHERE LOCAL WATER PRESSURE IS IN EXCESS OF EIGHTY(80) LBS. PER. SQ. IN. AN

APPROVED TYPE PRESSURE REGULATOR PRECEDED BY AN ADEQUATE STRAINER SHALL

DRAWN BY JLF PROJECT# 20-142 REV.1 REV.2

FINAL REV.

1/11/2021

TOTALFINSO/FT 3418

SHEET#

